ADDENDUM No. ONE (1) TO PROJECT DOCUMENTS ITB#6-2016/2017 Gulf Coast State College SOFTBALL COMPLEX PROJECT FLA Project No. 4228; Dewberry|Preble-Rish Project No. 50087410 June 1, 2017



#### **ADDENDUM NO. ONE (1)**

The Construction Drawings and/or Project Manual for the above project are amended in the following particulars and in these particulars only. All provisions of the original drawings and/or specifications shall remain in force, except as specifically modified or changed herein or by other Addenda issued by the Architect. This Addendum is hereby made part of the Contract Documents.

A Non-Mandatory Pre-Bid Conference was held May 30 at 10:00 a.m. at the GCSC Facilities Maintenance Office as advertised. This Addendum incorporates responses to questions received to date. Attached is the attendance Sign-In Sheet.

#### PROJECT MANUAL/SPECIFICATIONS (PM):

Item No. PM1: **REVISE** <u>Table of Contents</u> (TOC) to coordinate with Added and Deleted Sections (refer to attached updated Table of Contents):

- a. **DELETE** <u>Section 102810</u>, <u>Electric Hand Dryers</u> in TOC and Delete in body of Project Manual/Specifications (no longer required).
- b. **ADD** new <u>Section 133417, Press Box</u> to the TOC and in the body of the Project Manual/Specifications (refer to attached Section 133417).

Item No. PM2: **REVISE** Specification <u>Section 001000</u>, <u>Instructions to Bidders</u>; Item 1.22, Scheduling and Completion; **CHANGE** Paragraph C, Liquidated Damages line 9 to read as follows:

"Substantial Completion Liquidated Damages Per Day: \$1,500.00"

And **CHANGE** line 29 to read:

"Final Completion Liquidated Damages Per Day: \$1,500.00"

Item No. PM3: Refer to <u>Section 001000, Instructions to Bidders</u> Item 1.21, Post Bid Information Paragraph and **ADD** the following new paragraph:

"Provide the necessary information for the Owner to direct purchase the Pre-Engineered Metal Building (Section 133419) and the Structural Core Insulated Metal Building Panels (Section 074213). The Owner will order these systems within seven days of receipt of the information to save procurement time."

Item No. PM4: Refer to <u>Section 001000, Instructions to Bidders</u>; Exhibits "J, Labor and Material Payment Bond" and "K, Performance Bond". **CLARIFY** that these Exhibits/Bonds are not required with the Bid Proposal but shall be provided with the executed Contract.

Item No. PM5: Refer to <u>Section 008000, Supplementary General Conditions</u>, Article 8, Time; Paragraph 8.2.4, Progress and Completion and **CHANGE** the liquidated damages amounts for both Substantial Completion and Final Completion from \$3,000.00 to read "\$1,500.00".

Item No. PM6: Refer to <u>Section 011000, Summary;</u> Paragraph 1.06, Owner Furnished Products; and **ADD** the following:

"2. Owner will furnish the following Toilet Room Accessories for the Contractor to install where shown on the drawings:

Paper towel dispensers and disposal units,

Toilet paper dispenser units, Sanitary napkin disposal units,

Soap dispensers.

All other accessories shown on the drawings will be provided and installed by the Contractor."

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Item No. PM7: Refer to Section 072713, Self-Adhered Sheet Membrane Air Barrier; Paragraph 2.2.C,

Materials; and **ADD** the following approved product:

"2. AIR SHIELD™ by W.R. Meadows, Inc."

#### DRAWINGS:

#### LANDSCAPE ARCHITECTURE (LA) Refer to attached updated Drawings:

Item No. 1L: Refer to attached Drawing Sheet LS1, Landscape Addendum #1: CHANGE Plan around

Home and Visitor's Patios.

Refer to attached Drawing Sheet LS2, Irrigation Addendum #1: CHANGE Plan around Home Item No. 2L:

and Visitor's Patios.

#### ARCHITECTURAL (A) Refer to attached updated Drawings:

Item No. 1A: Refer to Cover Sheet A0.00: ADD Sheet AV-100, P.A System Plan to Index to Drawings and

insert the new sheet into the body of the drawings. ADD AV Consultant information to Cover

Sheet.

Item No. 2A: Refer to <u>Drawing Sheet A1.00, Site Plan</u> - **DELETE** step adjacent to the Home Dugout. **ADD** 

the 6'x4' gate to the Adjacent to the Home Locker Room.

Refer to Drawing Sheet A1.01, Sunscreen Layout - DELETE step adjacent to the Home Item No. 3A:

Dugout.

Item No. 4A: Refer to Drawing Sheet A1.04, Home Side Locker Room And Dugout Plan – CHANGE

> General Symbols Legend to reflect a semi recessed paper towel dispenser/disposal (D.D.) CHANGE one piece molded countertop length. DELETE T.B.'s (Trash Bin) and H.D.'s (Hand

Dryers and **REPLACE** with D.D.'s and notice some new locations.

Item No. 7A: Refer to Drawing Sheet A3.00, Sections And Details - DELETE H.D.'s (Hand Dryers). Notes

with respect to the Metal Building Manufacturer were modified (DELETE "By Others"). Metal

Building to be by Contractor.

Item No. 8A: Refer to <u>Drawing Sheet A7.31</u>, <u>Rest Rooms Interior Elevations</u> - **DELETE** H.D.'s (Hand

> Dryers) from Elevations and Legends. ADD D.D.'s (Paper Towel Dispensers/Disposal units added in Elevations in place of H.D.'s, ADD Grab Bar Note, ADD Changing Station Note. ADD Items furnished by the Owner and installed by Contractor Notes. Pre-molded Sink Note and Illustration adjusted. ADD Pre-molded drain and pipe jackets notes at each lavatory.

#### MECHANICAL (M) Refer to attached updated Drawings:

Item No. 1M: Refer to Drawing Sheet: M2, HVAC Schedules and Notes:

**CHANGE** DX Split System Air to Air Heat Pump Schedule.

Item No. 2M: Refer to Drawing Sheet: M3, HVAC Floor Plan – New Work:

**ADD** Sequence of Operations for Locker Room heat pump.

#### PLUMBING (P) Refer to attached updated Drawings:

Item No. 1P: Refer to Drawing Sheet P1, Plumbing Legend and Notes:



- a. ADD/CHANGE General Plumbing Notes 18 and 22.
- b. **ADD/CHANGE** Plumbing Fixture Schedule: P-4, P-11, & P-12.
- Item No. 2P: Refer to Drawing Sheet P2, Plumbing Details: **CHANGE** Electric water heater detail.
- Item No. 3P: Refer to <u>Drawing Sheet P4, Plumbing Locker Room Facility</u>:
  - a. ADD Plumbing fixtures in Locker Room and Laundry.
  - b. ADD Pipe sizes.
  - c. CHANGE Pipe routing to exterior hydrant.
- Item No. 4P: Refer to <u>Drawing Sheet P5, Plumbing Visitor Dugout & Risers</u>: **CHANGE** Waste & Vent Riser Diagram.

#### **ELECTRICAL (E) Refer to attached updated Drawings:**

- Item No. 1E: Refer to <u>Drawing Sheet E1, Electrical Site Plan</u>:
  - a. **CHANGE** Key Note Number to circuit LA-4.
  - b. **ADD** Key Note Number 22
  - c. **CHANGE** relay marks/designators for flag pole light, canopy lighting and parking lot lighting.
- Item No. 2E: Refer to <u>Drawing Sheet E2</u>, <u>Electrical Legend</u>:
  - a. **CHANGE** Manufacturer and model numbers for occupancy, daylight sensors and lighting controls.
  - b. ADD Lighting Control Wiring Diagram.
- Item No. 3E: Refer to <u>Drawing Sheet E3, Lighting Fixture Schedule</u>:
  - a. **DELETE** Crestron Lighting Control Wiring Diagram.
  - ADD WattStopper Lighting Control Wiring Diagram, Lighting Control Program Schedule.
  - c. CHANGE General Note.
- Item No. 4E: Refer to <u>Drawing Sheet E5, Electrical Home Locker Facility</u>:
  - a. **CHANGE** Wiring/circuiting for Office, Locker and Laundry areas.
  - b. ADD WattStopper Lighting Control panels and circuiting.
  - c. CHANGE General Note.
- Item No. 5E: Refer to <u>Drawing Sheet E6, Electrical Home Locker Facility</u>:
  - a. ADD Empty conduit note for DDC control panel.
  - b. ADD DDC Conduit note.
  - c. ADD EWC circuit.
  - d. **CHANGE** Key Notes 6 and 12.

#### AUDIO / VISUAL (AV) Refer to attached updated Drawings:

Item No. 1T: ADD New Drawing Sheet AV100, A/V Site Plan.

(continued next page)

ADDENDUM No. ONE (1) TO PROJECT DOCUMENTS
ITB#6-2016/2017 Gulf Coast State College
SOFTBALL COMPLEX PROJECT
FLA Project No. 4228; Dewberry|Preble-Rish Project No. 50087410
June 1, 2017



#### **OTHER QUESTIONS AND RESPONSES:**

- **Q1.** Is the Gulf Power underground conduits and Hand Hole also included in the Gulf Power scope of work or is it to be installed empty raceways by Electrical?
- **Q2**. Is Gulf Power providing the meter socket for the main or is the meter socket and wiring from meter to main panel included by Electrical?
- Q3. If Gulf Power is providing conduits do they need a stub out and if so what size do they require?

#### Response(s) Q1-Q3:

"Gulf Power will provide all underground feeds from the pole to the meter socket. Contractor does not need to include hand hole HH-1 indicated on the drawing E1 in his bid. Contractor shall provide the meter socket and schedule 80PVC to below grade where Gulf Power will tie in. Contractor shall provide conductor and conduit from the meter socket to the main panel. Contractor shall coordinate actual location of the meter socket on site with Gulf Power PRIOR TO ROUGH-IN. Contractor shall affirm with Gulf Power Company the arrangement and connection to the electrical utility service, as well as metering equipment, is in accordance with the requirements of Gulf Power Company."

End of Addendum No. 1

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#### **SECTION 000200 - TABLE OF CONTENTS**

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001000 Instructions to Bidders & Exhibits "C – K"

003100 Bid Proposal Form

004400 Bid Bond

007000 General Conditions of the Contract (AIA Document A201)

008000 Supplementary General Conditions

008200 Special Conditions 009000 Public Entity Crimes 009100 Trench Safety Affidavit

#### **DIVISION 01 - GENERAL REQUIREMENTS**

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013233 Photographic Documentation

013300 Submittal Procedures 013320 Routing Transmittal 014000 Quality Requirements

014200 References

015000 Temporary Facilities and Controls

015010 Project Sign

016000 Product Requirements

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055000 Metal Fabrications

DIVISION 06 - WOOD, PLASTIC AND COMPOSITES

061000 Rough Carpentry

DIVISION 07- THERMAL AND MOISTURE PROTECTION
072713 Self Adhered Sheet Membrane Air Barriers
074213 Structural Core Insulated Metal Building Panel

076100 Sheet Metal Roofing 077200 Roof Accessories 079200 Joint Sealants

DIVISION 08 - 081113 081416 084117 087100 088000 089000	OPENINGS Hollow Metal Doors & Frames Flush Wood Doors Interior Aluminum Framed Entrances & Storefronts Finish Hardware Glazing Louvers & Vents
DIVISION 09 – 092216 092400 092900 093000 095113 096513 096723 099113 099123 099600	FINISHES Non-Structural Metal Framing Portland Cement Plastering Gypsum Board Tiling Acoustic Panel Ceilings Resilient Base and Accessories Seamless Resinous Flooring Exterior Painting Interior Painting High Performance Coatings
DIVISION 10 – 101246 101400 101423 102113 102800 102810 104413 104416 107500 105126	Monument Signage Plaque Signage Panel Signage Toilet Compartments Toilet And Bath Accessories Electric Hand Dryers (DELETED) Fire Extinguisher Cabinets Fire Extinguishers Flagpoles Plastic Lockers
DIVISION 11 - 116843	EQUIPMENT Scoreboard
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DIVISION 22 - 220050 220060	PLUMBING Plumbing Plumbing Fixtures and Trim
DIVISION 23 – 230050 230080 230120 230530 230600 230750 230850 230950	HEATING, VENTILATING AND AIR CONDITIONING Mechanical General Requirements Insulation of Mechanical Systems Split System Heat Pump Units 100% Outside Air Units VRV Units Exhaust Fans Ductwork & Ductwork Accessories Testing, Adjusting & Balancing

DIVISION 26 -	ELECTRICAL
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260000 Electrical General Provisions 262000 Low Voltage Switchboard 264020 Interior Wiring Systems 265100 Interior Lighting

#### **DIVISION 30 - SITE WORK**

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302110 Site Clearing

302830 Chain Link Fencing & Gates 303310 Site Work Concrete Work

#### DIVISION 31 – EARTHWORK

312200 Earthwork

312222 Trenching, Backfilling, and Compacting

313116 Termite Control

#### **DIVISION 32 - EXTERIOR IMPROVEMENTS**

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#### **DIVISION 33 - UTILITIES**

335010 Basic Mechanical Requirements
335051 Mechanical Related Work
335080 PVC Gravity Sewer
335101 Valves and Accessories

Appendix A Geotechnical Engineering Report

END OF SECTION 000200

#### **SECTION 133417 - PRESS BOX**

PART 1 - GENERAL

#### 1.01 APPLICABLE CODES AND STANDARDS

A. Florida Building Code – 2014 latest edition adopted in building area. Building Code Requirements for Grandstand Structures and Press Box.

#### 1.02 RELATED DOCUMENTS

- A. Drawings and general provisions of Contract, including General and Supplementary Conditions, Special Conditions and Division One sections, apply to work to this section.
- B. Refer to Section 051200, Structural Steel Framing for steel framing members.
- C. Refer to Section 074213, Steel Clad Insulated Building Panels for roof deck and wall panels.
- D. Refer to Section 076100, Sheet Metal Roofing for roof membrane.
- E. Refer to Section 133416, Grandstands for bleacher type seating.
- F. Refer to Section 072713, Self-Adhering Membrane Air Barrier for roof membrane underlayment.

#### 1.03 PERFORMANCE CRITERIA & SCOPE OF WORK

- A. Provide an outdoor permanent Press Box: Pre-engineered, pre-fabricated and installed for the complex <u>as shown on drawings</u> and detailed in these performance specifications. The purpose of the Press Box is to provide a space(s) for reporters and announcers to work during the athletic events. Drawing intent is for the Grandstand manufacturer to also provide the Press Box for one integrated structure.
- B. The minimum acceptable standards of design are:
  - Press Box is elevated and located per Architect's plans. Overall length and width per Architect's drawings.
  - 2. Press Box integration with the grandstand per Architect's drawings.
  - 3. Architect's drawings denote specific project requirements. This specification cover all other performance requirements.
  - 4. Finishes to be: "hot dipped" galvanized on the steel understructure; High Performance Dur-Kyn paint on the aluminum aisle nosing strips at aisles and stairs color black; Dur-Kyn High Performance painted finish on aluminum stair risers color Charcoal Gray. Perimeter Rail risers to be hot dipped galvanized, rails to be clear anodized. Along the back and sides of the stand the railing system will be Aluminum vertical picket rails color black.
  - 5. Proper modular labels as may be required.

#### 1.04 RELATED WORK/ RELATED SECTIONS

- A. In accordance with plans and specifications:
  - 1. Bleacher Seating by Grandstand Manufacturer.
  - 2. Concrete Foundations designed by grandstand & press box manufacturer and install by G.C.

3. Site improvements and restoration by G.C.

#### 1.05 QUALITY ASSURANCE

#### A. Manufacturers Qualifications:

- 1. Manufacturers must have a minimum of (10) ten years of experience in the manufacturing of grandstands and press boxes under current company name.
- 2. Manufacturer must provide five references (upon request) of similar projects within the State of Florida. References shall include scope of work, contract amount, owner's name and phone numbers, contract completion date and actual completion date.
- 3. Manufacturer shall have local representation or project superintendent within a one-hundred-fifty-mile radius of the project. Representative is responsible to attend job site meetings, provide sequencing and scheduling information and make decisions on behalf of the manufacturer. Due to the coordination and timeframe of each project, it is imperative that this representative can immediately respond, in person, to evaluate questions, concerns and actions, resolve issues that immediately impact the fabrication and installation of the product or other contractors' abilities to proceed with their work. Resume of representatives needs to be submitted for review and approval.
- 4. If approved bidder is a dealer or representative of the manufacturer in addition to the manufacturer the dealer must provide the same information required in this section.
- 5. Welders must be AWS certified; manufacturing capabilities in accordance with the governmental agencies having jurisdiction.
- Manufacturers must be a participant in the AISC Certification program and have proof of certification at time of bid.
- 7. Engineer qualifications: The press box shop drawings shall be signed and sealed by a Florida registered professional engineer.

#### B. Installers Qualifications:

- 1. Factory-trained and experienced in the installation of grandstands and press boxes.
- C. Source Quality Control: Mill Test Certification.
- Single Source Responsibility: Obtain all of each distinct material required from a single manufacturer.
- E. Code Compliance: Provide press box to meet or exceed all State applicable codes and in compliance with the FBC, IBC/ICC National Code and along with other relevant State Codes and Regulations.

#### 1.06 SUBMITTALS

- A. Product Data: Submit technical data for each distinct type of material, component and accessory indicated.
  - Include information which specifically details physical properties and performance characteristics.
- B. Shop Drawings: Manufacturer to submit shop drawings and structural design calculations signed and sealed by a Florida licensed professional engineer, and schedules for type, location, quantity and details of all components required for this project. Indicate on shop drawings that products are in compliance with the FBC, IBC/ICC National Building Code and all other State Regulations.
- C. Concrete designed per American Concrete Institute Guidelines.

05/31/2017-Addendum #1 133417 Press Box Page 2 of 6

- D. Samples: Submit manufacturer's samples for the following components as requested with the submission
  - Roofing
  - 2) Glazing
  - 3) Ceiling
  - 4) Flooring
- E. Certificate: Submit manufacturer's certification that materials furnished comply with requirements indicated on the Architect's drawings, specified herein, and in compliance with the FBC, IBC/ICC code and all other applicable Federal and State codes/requirements, and that materials meet or exceed test requirements indicated.

#### 1.07 WARRANTY

A. Submit a written warranty signed by the manufacturer, installer, and the contractor, guaranteeing to correct failures for a period of Two (2) years after substantial completion, without reducing or otherwise limiting any other rights to correction which owner may have under the contract documents. Failures are defined to include faulty workmanship or faulty materials. Correction may include repair or replacement.

#### 1.6 BUILDING CODES

- A. Comply with all applicable which includes but not limited to the following:
  - 1. Florida Building Code, IBC/ICC Building Codes- Current Edition
  - 2. AISC Manual of Steel Construction, 9th Edition
  - 3. Aluminum Association of America Guidelines
  - 4. American Concrete Institute
- B. The bleacher shall be designed to support, in addition to its own weight: a uniformly distributed live load of not less than 100 pounds per square foot of gross floor area; 50 pounds per square foot of live load on roof. The wind load will need to account for the enclosed structure created by the press box.
- C. Design Classification: Use Group B, Construction Type II-B Steel Framed, Non-Combustible.
- D. General: The structure shall be properly braced for wind and construction loads until all structural elements are secured. Lateral and longitudinal bays shall be cross-braced as required. Guardrails shall be of adequate size, location, and height to meet specified codes and designed to carry required loads. Exit stairs and intermediate aisle stairs shall be completely closed, in the direction of travel and shall have a maximum rise of 7" and a minimum tread of 11" as shown on the Architect's drawings.
- E. Design Compliance: Submittals shall be based upon specifications and drawings contained in the bid documents. Architect will not review any design or product changes prior to the bid date. Design changes to reduce overall: size and quality; aisle egress calculations; number and types of windows; or number of stairs and exits will not be allowed.

#### 1.7 MAINTENANCE

A. Manufacturer's Recommendations:

Owner conduct annual visual inspection and required maintenance of grandstand and press box to assure safe conditions. It is also recommended that a professional engineer, registered architect or certified grandstand representative performs inspections biennially.

#### **PART - 2**

#### 2.01 PRODUCT MANUFACTURERS

- A. The Design intent is based on product provided by: Southern Bleacher Company (800) 433-0912; Graham TX. Dant Clayton Corporation, Louisville, KY is an approved equal provided compliance with drawings and specifications.
- B. Products specified herein have been selected because of their quality of construction, configuration, design, function, available finishes, components, accessories, dimensions, shape and style.
- C. Bidder and/or Contractor will be held financially responsible for adhering to the products specified herein and as detailed on the drawings.
- F. Only the Architect reserves the right to accept or approve Grandstand and Press Box manufacturers. Refer also to Section 008200, Special Conditions, Article 15, Substitution of Materials and Equipment for additional substitution information and requirements.

#### 2.02 PERMANENT STEEL PRESS BOX

- A. Product Description Exterior Interlock Decking System:
  - 1. The intent of the exterior deck, stairs, railings and other related components and finish product design is to match the grandstand specification in Section 133416.

#### B. Substructure and Floor Construction:

- 1. Substructures:
  - a. Structural shapes meet one of the following ASTM specifications: A36, A36/A572 grade 50, A572 grade 50, A529-50, or A500 grade B.
  - b. Shop connections are seal welds.
  - c. After fabrication, all steel is hot-dipped galvanized to ASTM-A-123 specifications. Painted and/or powder coated steel does not offer proper protection and is not an acceptable protective finish for this project.
  - d. All hardware shall be hot-dipped galvanized to ASTM A-123, mechanically galvanized or aluminum (aluminum applies to pop rivets, drive rivets, wire ties).
  - e. A minimum of 3/8" galvanized connection hardware to be used on the substructure.

#### 2. Floor Construction:

- a. Bottom Board: .029 GA. one-piece galvanized steel underbelly.
- b. Joists: (Welded Framing): 60 CSJ16, 6" X 16ga. Galvanized steel joists, on 16" centers, longitudinal framing.
- c. Insulation: 6" R-19 fiberglass batt insulation w/ vapor barrier.
- d. Steel Pan: 26GA. 1.0E steel deck (4 screws/33" Length S-12 Tek).
- e. Decking: 1/4" Fibered cement board, class A F.S.R.
- f. Covering: Per Architect's Drawings, Finish Schedule and related Specifications.

#### C. Walls:

1. Wall Construction – 3" Steel Clad Insulated Metal Building Panels (Section 074213) or the following:

- a. Studs: (Welded Framing): 6" X 18 GA. Galvanized steel studs, on 16" centers.
- b. Headers: Galvanized steel joists as span requires.
- c. Ceiling Height: 8'-2" x 8'-0", front to back.
- d. Interior Covering: 5/8" Type-X painted gypsum panels, Class A, F.S.R.
- e. Insulation: 8" R-24 fiberglass batt insulation w/ vapor barrier.
- f. Sheathing: 5/8" Type-X Fire-Rated, exterior grade gypsum, class A F.S.R. with wrap air infiltration barrier.
- g. Siding: Metal Sales "R-Panel" .024 GA. Ribbed steel panels w/ Kynar 500 finish -FL#9482.4-R4.

#### G. Roof:

- 1. Roof Construction 4" Steel Clad Insulated Metal Building Panels (Section 074213) or the following:
  - a. Joists: (Welded Framing): 10" X 16ga. Welded galvanized steel joists, 16" O.C. spacing.
  - b. Overhang: per Architect's drawings: .019 Metal fascia Mastic Aluminum soffit panels, full perimeter of press box.
  - c. Ceiling: per Architect's drawings, Finish Schedule and related Specifications.
  - d. Decking & Insulation: 1/2" Fibered cement board, class A F.S.R.
  - e. Insulation: 8" R-24 fiberglass batt insulation w/ vapor barrier.
  - f. Membrane: Sheet Metal Roofing per Section 076100 over Membrane Air Barrier Section 072713.

#### H. Windows and Doors:

- 1. Windows: Per Architect's drawings and related Specifications.
- 2. Exterior Doors: 36"x80" Ceco "Versa" Polyurethane core 16GA. Galvanized hollow metal door w/ steel framed, weather-strip, aluminum ADA threshold, and lever handled locksets. FL#10723-R1.
- 3. Interior Doors: 1-3/8" Solid-core stained birch with stained birch wood jambs and casing and passage lever handled hardware.

#### I. Electrical & HVAC:

- 1. Service Entrance Panel: Square D Q0124M100 with Main Disconnect; rated at 120/240v, single phase, 100-amp capacity.
- 2. Receptacles:
  - a. Two (2) Pass & Seymour 120V duplex, spec-grade, along the rear wall.
  - b. Wiremold 5400 Series two-piece multi-channel, dual voltage, non-metallic surface raceway along front wall above scorer's counter, outlets on 48" centers.
- 3. Lighting per Architect's drawings and related Specifications.
- 4. Circuits: All branch circuit wiring is minimum #12 THHN encased in EMT thin wall conduit.
- 5. HVAC: (2) Zoneline AZ61H07DAB 2.4 KW Electric wall mount heat pump unit.

#### J. Scorer's Counter:

1. 18" deep x 1 ½" Clear Anodized finish aluminum countertop with rounded front nose. Mounted on stainless steel brackets spaced a maximum of 32".

#### PART 3 - EXECUTION

#### 3.01 <u>INSTALLATION</u>

A. All work performed by technicians experienced in Press Box installation. Project references may be required to verify the quality of finished projects.


Installation with proven experience in the Florida panhandle region. Requirement for a minimum of (3) installer references in FL for this project of similar size and scope.


- B. Project is only to be installed as per approved shop drawings.
- C. General Contractor is responsible to furnish and complete all foundations (spread footings and grade beams). All site restoration, including rough and final grade, topsoil and lawn re-establishment shall be provided by G.C.
- D. Provide all necessary pads, anchors, flashings, etc. to connect press box with grandstand structure to the concrete foundations as indicated on the drawings.
- E. Coordinate electrical power connection to the press box electrical panel as indicated on the drawings. Connection to electrical power service shall be by the G.C.

#### 3.02 CLEAN-UP

- A. Clean up all debris caused by work of this section removed from site.
- B. Upon completion of the work and final inspections, press box manufacturer shall broom clean the facility removing all loose debris.
- C. If broom cleaning does not properly remove dirt and debris from the surface, pressure washing will be required on the exterior.
- D. Clean glass per Glazing Specification.
- E. Clean up of loose debris through-out the project shall occur daily. The materials shall be placed in a GC provided dumpster.

END OF SECTION 133417

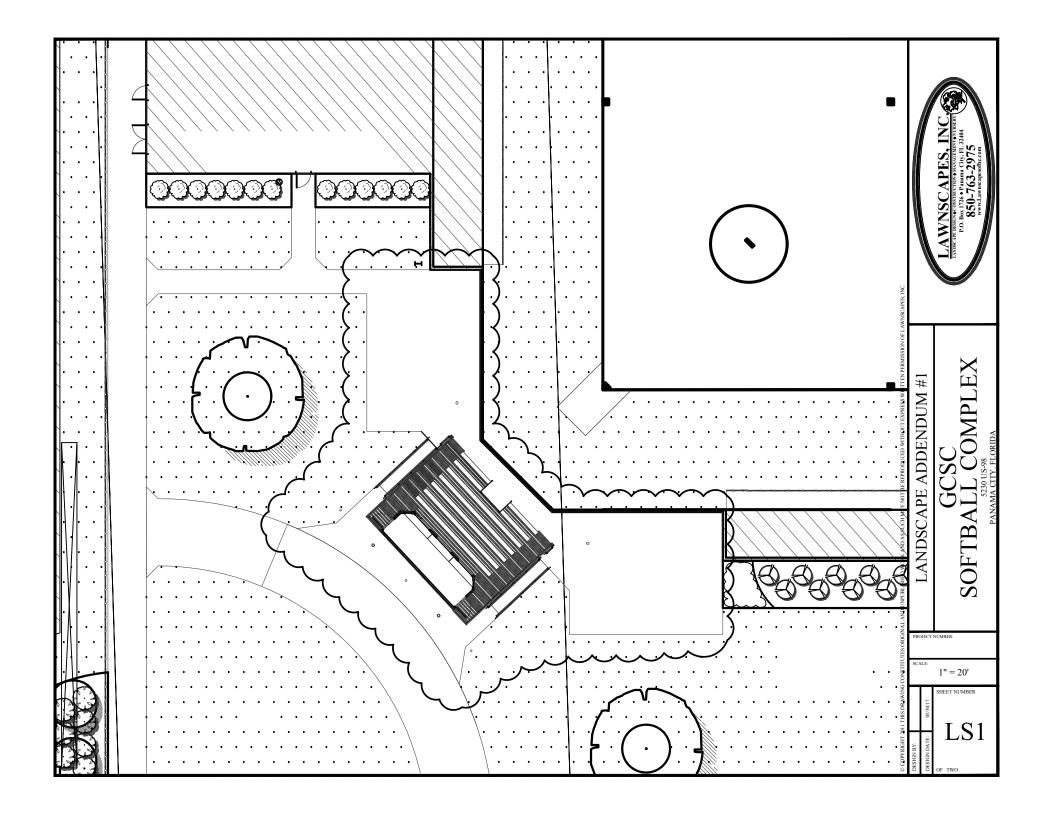

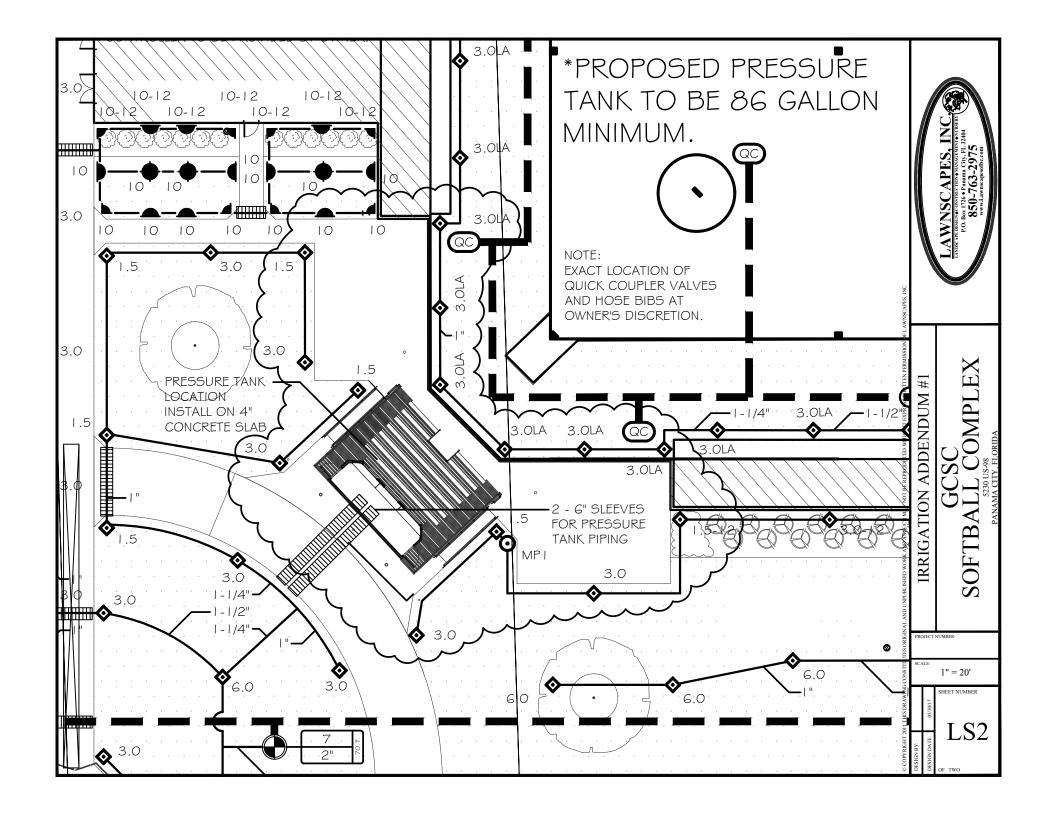




# GCSC SOFTBALL COMPLEX

5230 US-98 PANAMA CITY, FLORIDA 32401

## CONSTRUCTION DOCUMENTS


## 3D VIEWS

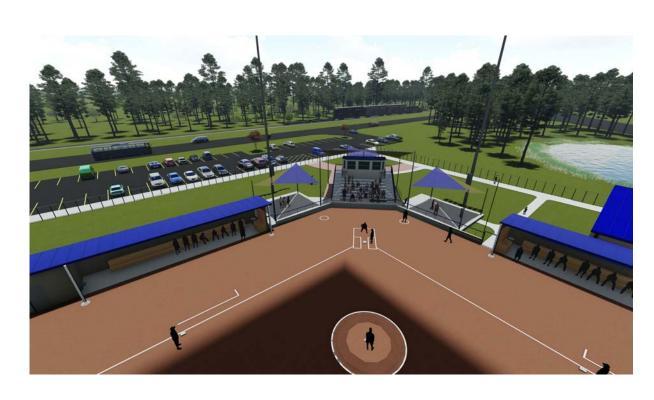





## VINICITY MAP

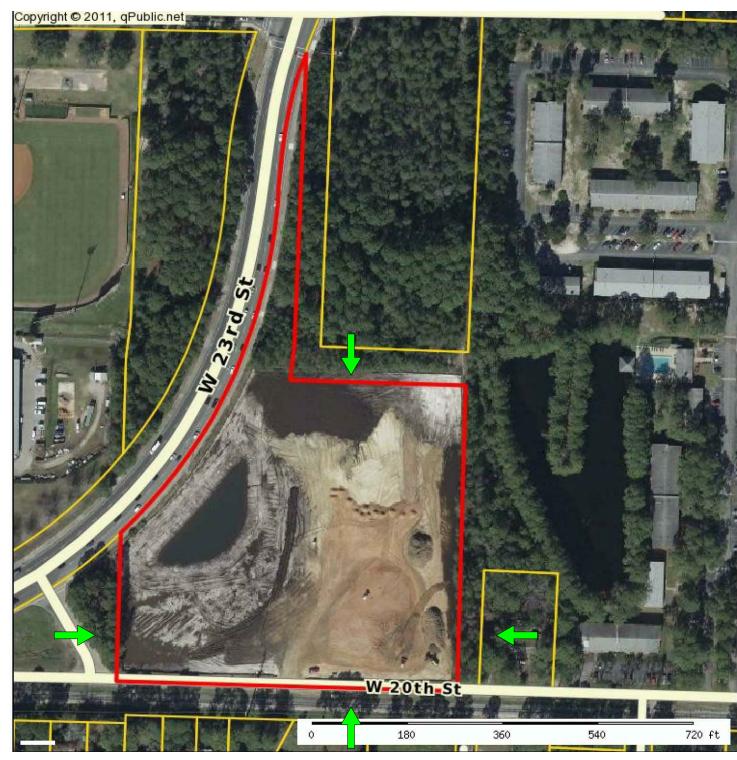

## DESIGN CODES

FLORIDA BUILDING CODE (FBC)	2014 ED
FBC - PLUMBING CODE	2014 ED
FBC - ENERGY CONSERVATION CODE	2014 ED
FBC - ACCESSIBILITY CODE	2014 ED
NEC - NATIONAL ELECTRIC CODE	2014 ED
FLORIDA FIRE PREVENTION CODE	2014 ED
LIFE SAFETY CODE (NFPA 101)	2015 ED
AMERICANS WITH DISABILITIES ACT	2014 ED

TO THE BEST OF OUR KNOWLEDGE, THESE CONSTRUCTION DOCUMENTS ARE IN COMPLIANCE WITH CRITERIA SET FORTH IN THE 2014 FLORIDA BUILDING CODE.

## CODE REVIEW ANALYSIS

## PROJECT SUMMARY

DEVELOPMENT AND CONSTRUCTION OF A NEW SOFTBALL COMPLEX, LOCKER ROOM, DUGOUTS, PRESS BOX, BLEACHERS, MAINTENANCE BUILDINGS, AND OTHER IMPROVEMENTS.

CLASSIFICATION OF MORK

NEW CONSTRUCTION

OCCUPANCY CLASSIFICATION
ASSEMBLY GROUP A-5

## INDEX OF DRAWINGS:

## CIVIL

	DRAWING SCHEDULE
SHEET	NAME
<b>C</b> 1	GENERAL NOTES
C2	EXISTING CONDITIONS
C3	EROISON CONTROL PLAN
C4	SITE GEOMETRY
C5	GRADING & DRAINAGE PLAN
C6	FIELD GRADING & DETAIL PLAN
C7	FIELD DETAIL PLAN
C8	UTILITY PLAN
D1	SMPPP
D2-D5	DETAILS

## LANDSCAPE

CUEET	DRAWING SCHEDULE					
SHEET	NAME					
L-1	LANDSCAPE PLAN					
L-2	IRRIGATION PLAN					
L-3	IRRIGATION PLAN					

DRAWING SCHEDULE

NAME

AO.00 COVER SHEET / DRAWINGS INDEX /

## ARCHITECTURAL

	VICINITY MAP/ LEGENDS
	DRAWING SCHEDULE
SHEET	NAME
A1.00	SITE PLAN
A1.01	SUNSCREEN LAYOUT
A1.02	HOME SIDE LOCKER ROOM FACILITY LIFE SAFETY PLAN
A1.03	HOME AND VISITOR DUGOUT FLOOR PLAN
A1.04	HOME SIDE LOCKER RM. AND DUGOUT PLAN
A1.05	PRESS BOX FLOOR PLAN
A1.06	ROOF PLAN
A1.11	REFLECTED CEILING PLAN
A2.00	HOME SIDE LOCKER ROOM FACILITY ELEVATIONS
A2.01	HOME DUGOUT ELEVATIONS
A2.02	VISITOR DUGOUT ELEVATIONS
A2.03	PRESS BOX ELEVATIONS
A3.00	SECTIONS AND DETAILS
A3.01	SECTIONS AND DETAILS
A4.00	FINISH SCHEDULE
A7.31	RESTROOMS INTERIOR ELEV.
A8.10	MALL TYPES/DETAILS

## STRUCTURAL

CUEET	DRAWING SCHEDULE				
SHEET	NAME				
5-001	STRUCTURAL NOTES				
5-101	HOME SIDE FOUNDATION PLAN				
5-102	BLEACHER FOUNDATION PLAN				
5-103	VISITOR FOUNDATION AND SLAB PLAN				
5-104	HOME SIDE SLAB PLAN				
5-105	BLEACHER SLAB PLAN				
5 106	SCOREBOARD FOUNDATION				
5-301	BUILDING SECTIONS				
5-302	BUILDING SECTIONS				
5-501	DETAILS				

## MECHANICAL

CUEET	DRAWING SCHEDULE
SHEET	NAME
M 1	HVAC LEGEND AND NOTES
M 2	HVAC SCHEDULES AND NOTES
мз	IRRIGATION PLAN
M 4	HVAC FLOOR PLAN - NEW WORK
M 5	HVAC DETAILS

## PLUMBING

CUEET	DRANING SCHEDULE
SHEET	NAME
P 1	PLUMBING LEGEND AND NOTES
P 2	PLUMBING DETAILS
P 3	PLUMBING - SITE PLAN
P 4	PLUMBING - LOCKER ROOM FACILITY
P 5	PLUMBING - VISITOR DUGOUT & RISERS

## ELECTRICAL

SHEET	NAME
E 1	ELECTRICAL SITE PLAN
E 2	ELECTRICAL LEGEND
E3	LIGHTING FIXTURE SCHEDULE
E 4	ELECTRICAL PRESS BOX
E 5	ELECTRICAL HOME LOCKER FACILIT
E6	ELECTRICAL HOME LOCKER FACILITY
Ε7	ELECTRICAL VISITOR DUGOUT & STORAGE BULDING
Eδ	ELECTRICAL PANEL SCHEDULES
E 9	ELECTRICAL DETAILS
E 10	ELECTRICAL DETAILS
E 11	ELECTRICAL DETAILS
E 12	ELECTRICAL DETAILS
E 9 E 10 E 11	ELECTRICAL DETAILS ELECTRICAL DETAILS ELECTRICAL DETAILS

DRAWING SCHEDULE

## AUDIO/ VISUAL

NUMBER

CUEET	DRAWING SCHEDULE						
SHEET	NAME						

## 1-100 VISITOR DUGOUT 1-101 VISITOR STORAGE

1 10 1	11511511511110	000
2-100	HOME DUGOUT	569 SF
2-102	HOME STORAGE	71 SF
2-103	VEST.	48 SF
2-104	LOCKER ROOM	504 SF
2-105	VESTIBULE	59 SF
2-106	OFFICE	105 SF
2-107	TLT.	54 SF
2-108	RESTROOM	346 SF
2-109	LAUNDRY	204 SF
2-110	MOMEN RESTROOM	134 SF
2-111	MEN RESTROOM	149 SF
2-112	MEP	193 SF
GRAND TOTAL		3073 SF

ROOM SCHEDULE

#### PROJECT DIRECTORY:

## ARCHITECTURAL

FLORIDA ARCHITECTS, INC. 648 FLORIDA AVE. PANAMA CITY, FL 32401 PHONE: 850/257-5400 P

#### STRUCTURAL

ANDERSON ENGINEERS, P.A.
78 RICKER AVENUE
SANTA ROSA BEACH, FL 32459
PHONE: 850.231.4540
FAX: 850.231.7980

#### ELECTRICAL & COMMUNICATIONS

PREMIER ENGINEERING GROUP, LLC 410 M. NINE MILE ROAD, SUITE A PENSACOLA, FL 32534 PHONE: 850.469.0405 FAX: 850.432.0905

## MECHANICAL & PLUMBING

PREMIER ENGINEERING GROUP, LLC. 410 M. NINE MILE ROAD, SUITE A PENSACOLA, FL 32534 PHONE: 850.469.0405 FAX: 850.432.0905

## LANDSCAPE ARCHITECT

LAWNSCAPES, INC. P.O. BOX 1726 PANAMA CITY, FL 32404 PHONE: 850.763.2975

## AUDIO/ VISUAL

MATHALL & ASSOCIATES 2180 CREISHTON ROAD PENSACOLA, FL 32504 PHONE: 850.478.9002

## GULF

GULF COAST STATE
COLLEGE

**Dew**berry PREBLE-RISH

5230 US-98 PANAMA CITY, FLORIDA 32401 850-169-1551 gulfcoast.edu

## PROJECT:

GCSC SOFTBALL COMPLEX

ITB # 6 - 2016/2017



PHONE: (850) 231-4540 FAX: (850) 231-7980

Certificate of Authorization: # 25932





RELEASE:

CONSTRUCTION DOCUMENTS

SCALE	<b>:</b> :	DATE: 05/04/20	)17
DRAV N. PE		CHECKED: R. DAVIS	
NO.	REVISION:		DAT
1	ADDENDUM No	.1	05/


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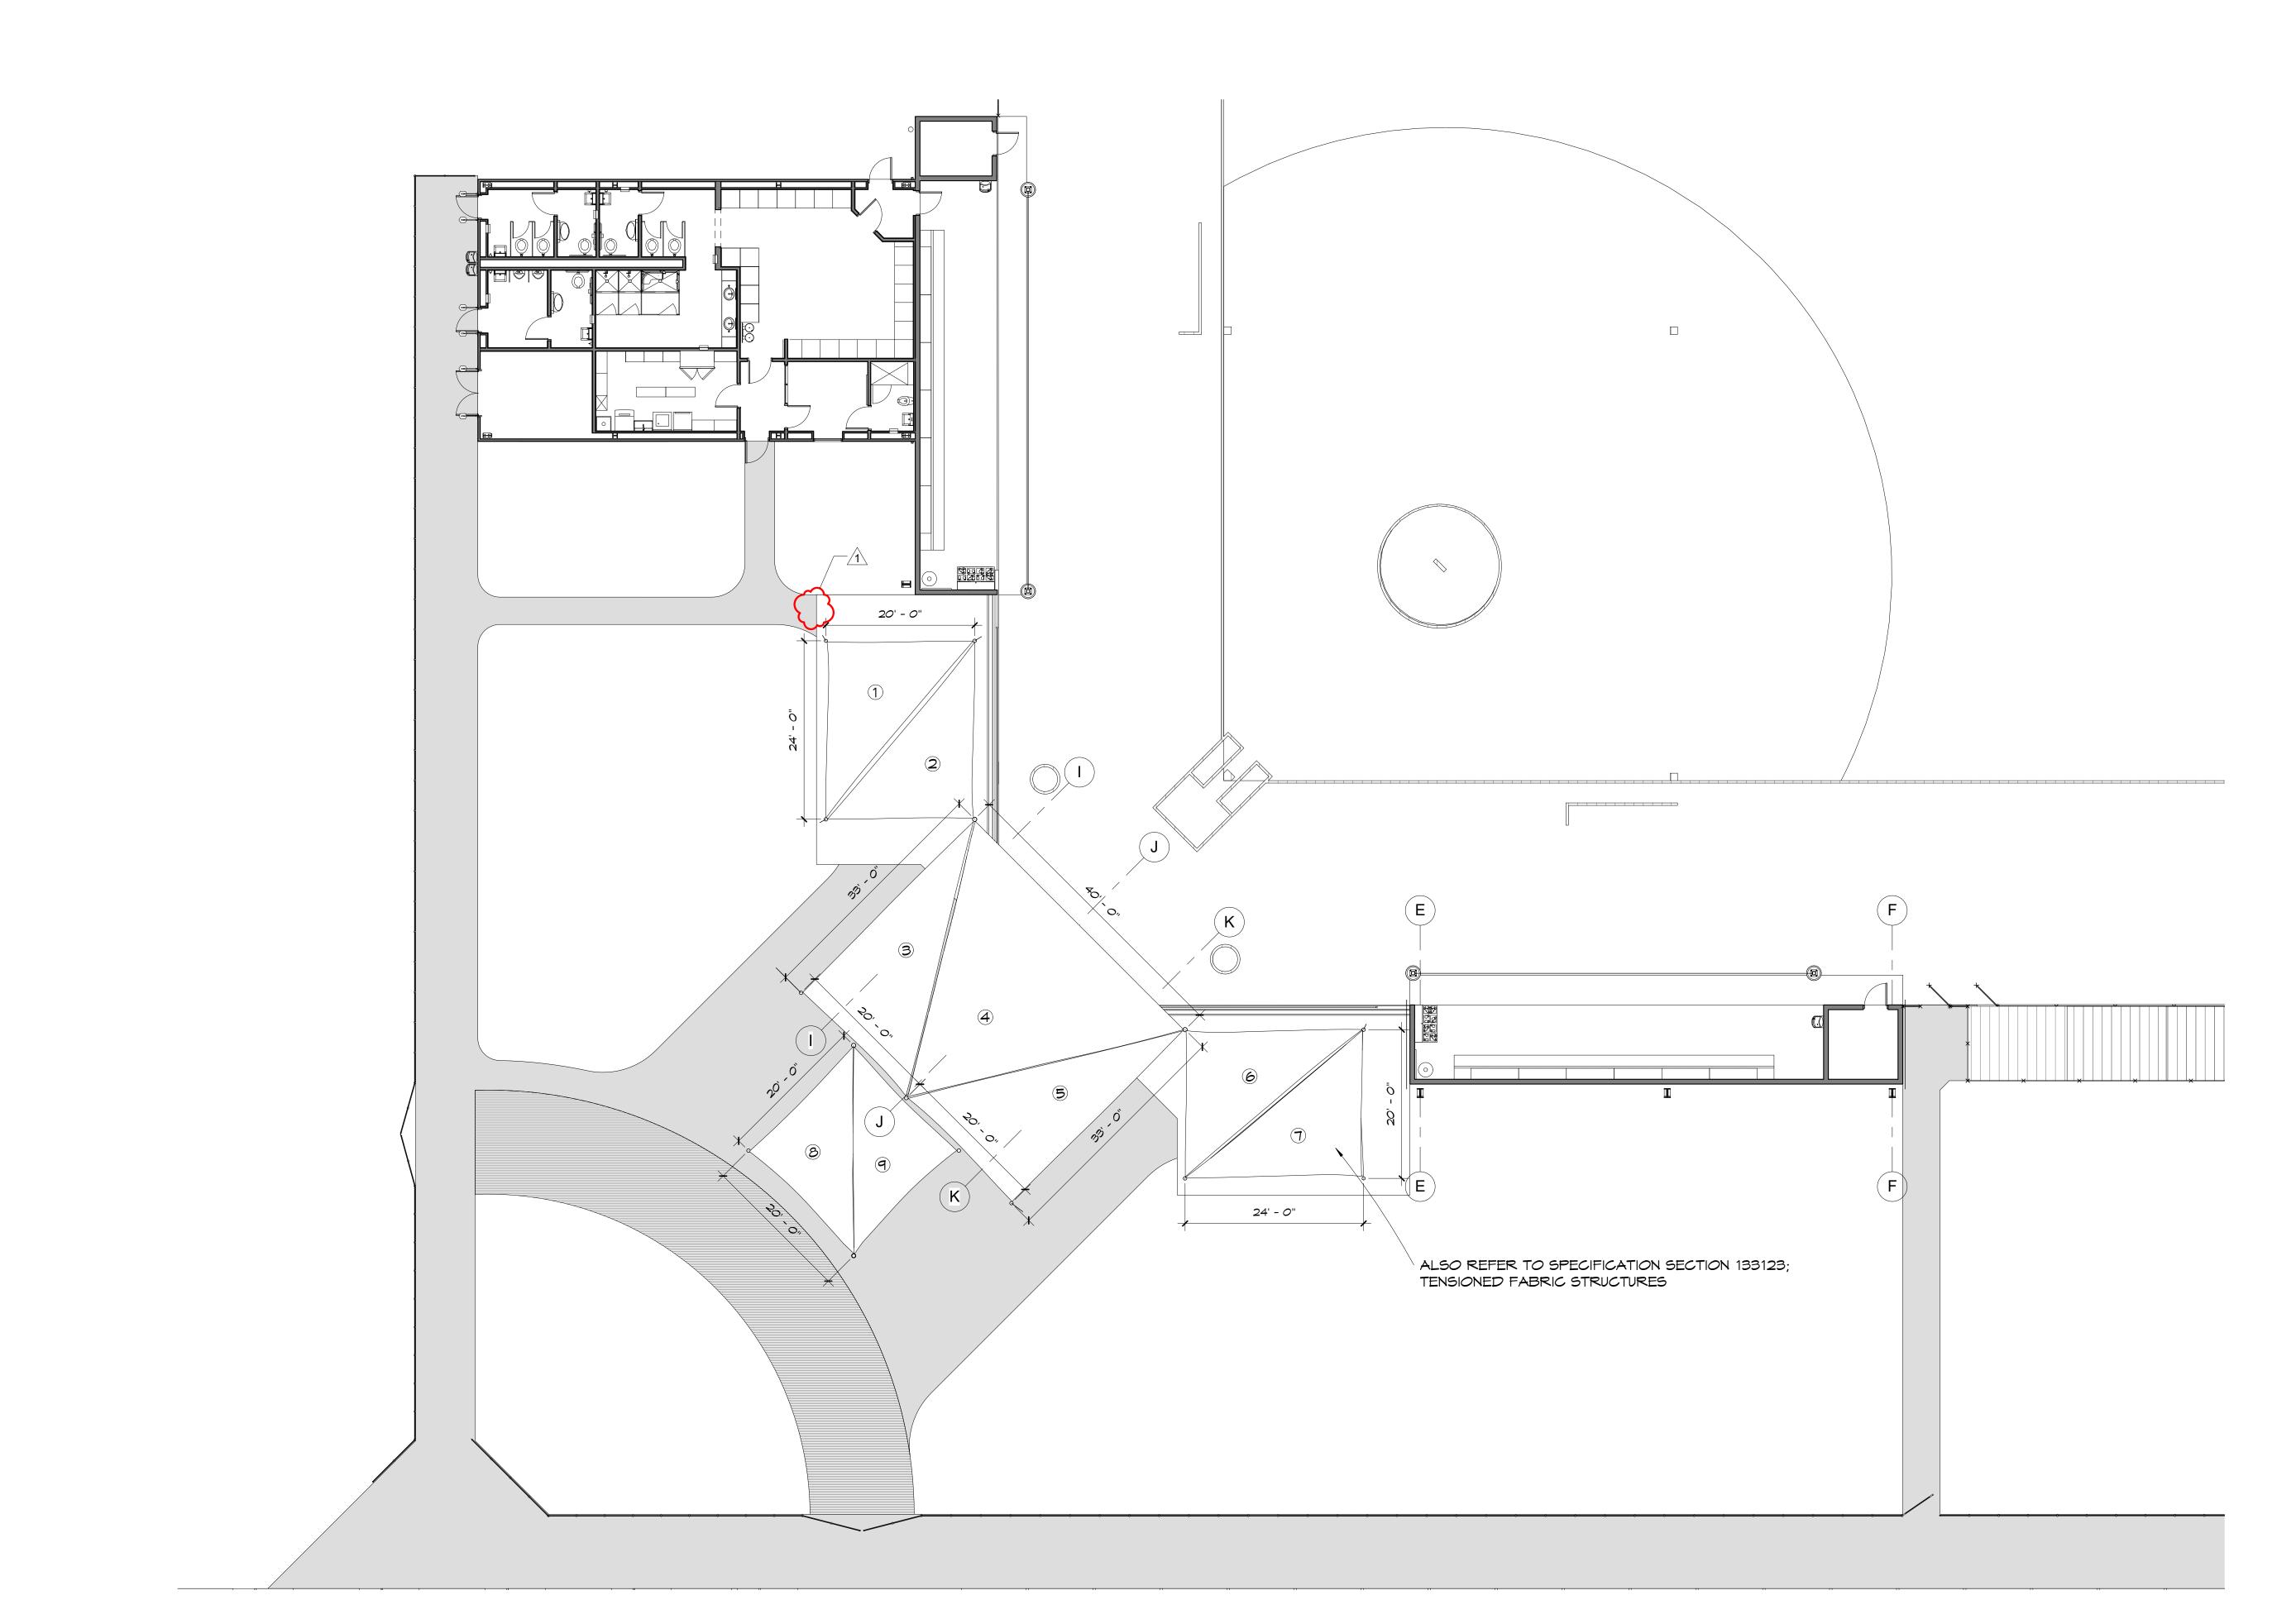
PROJECT NO. 4228


4228 A0.00

ERRY I PREBLE-RISH ALL RIGHTS RESERVED. NO PART OF THIS DOG

SHEET



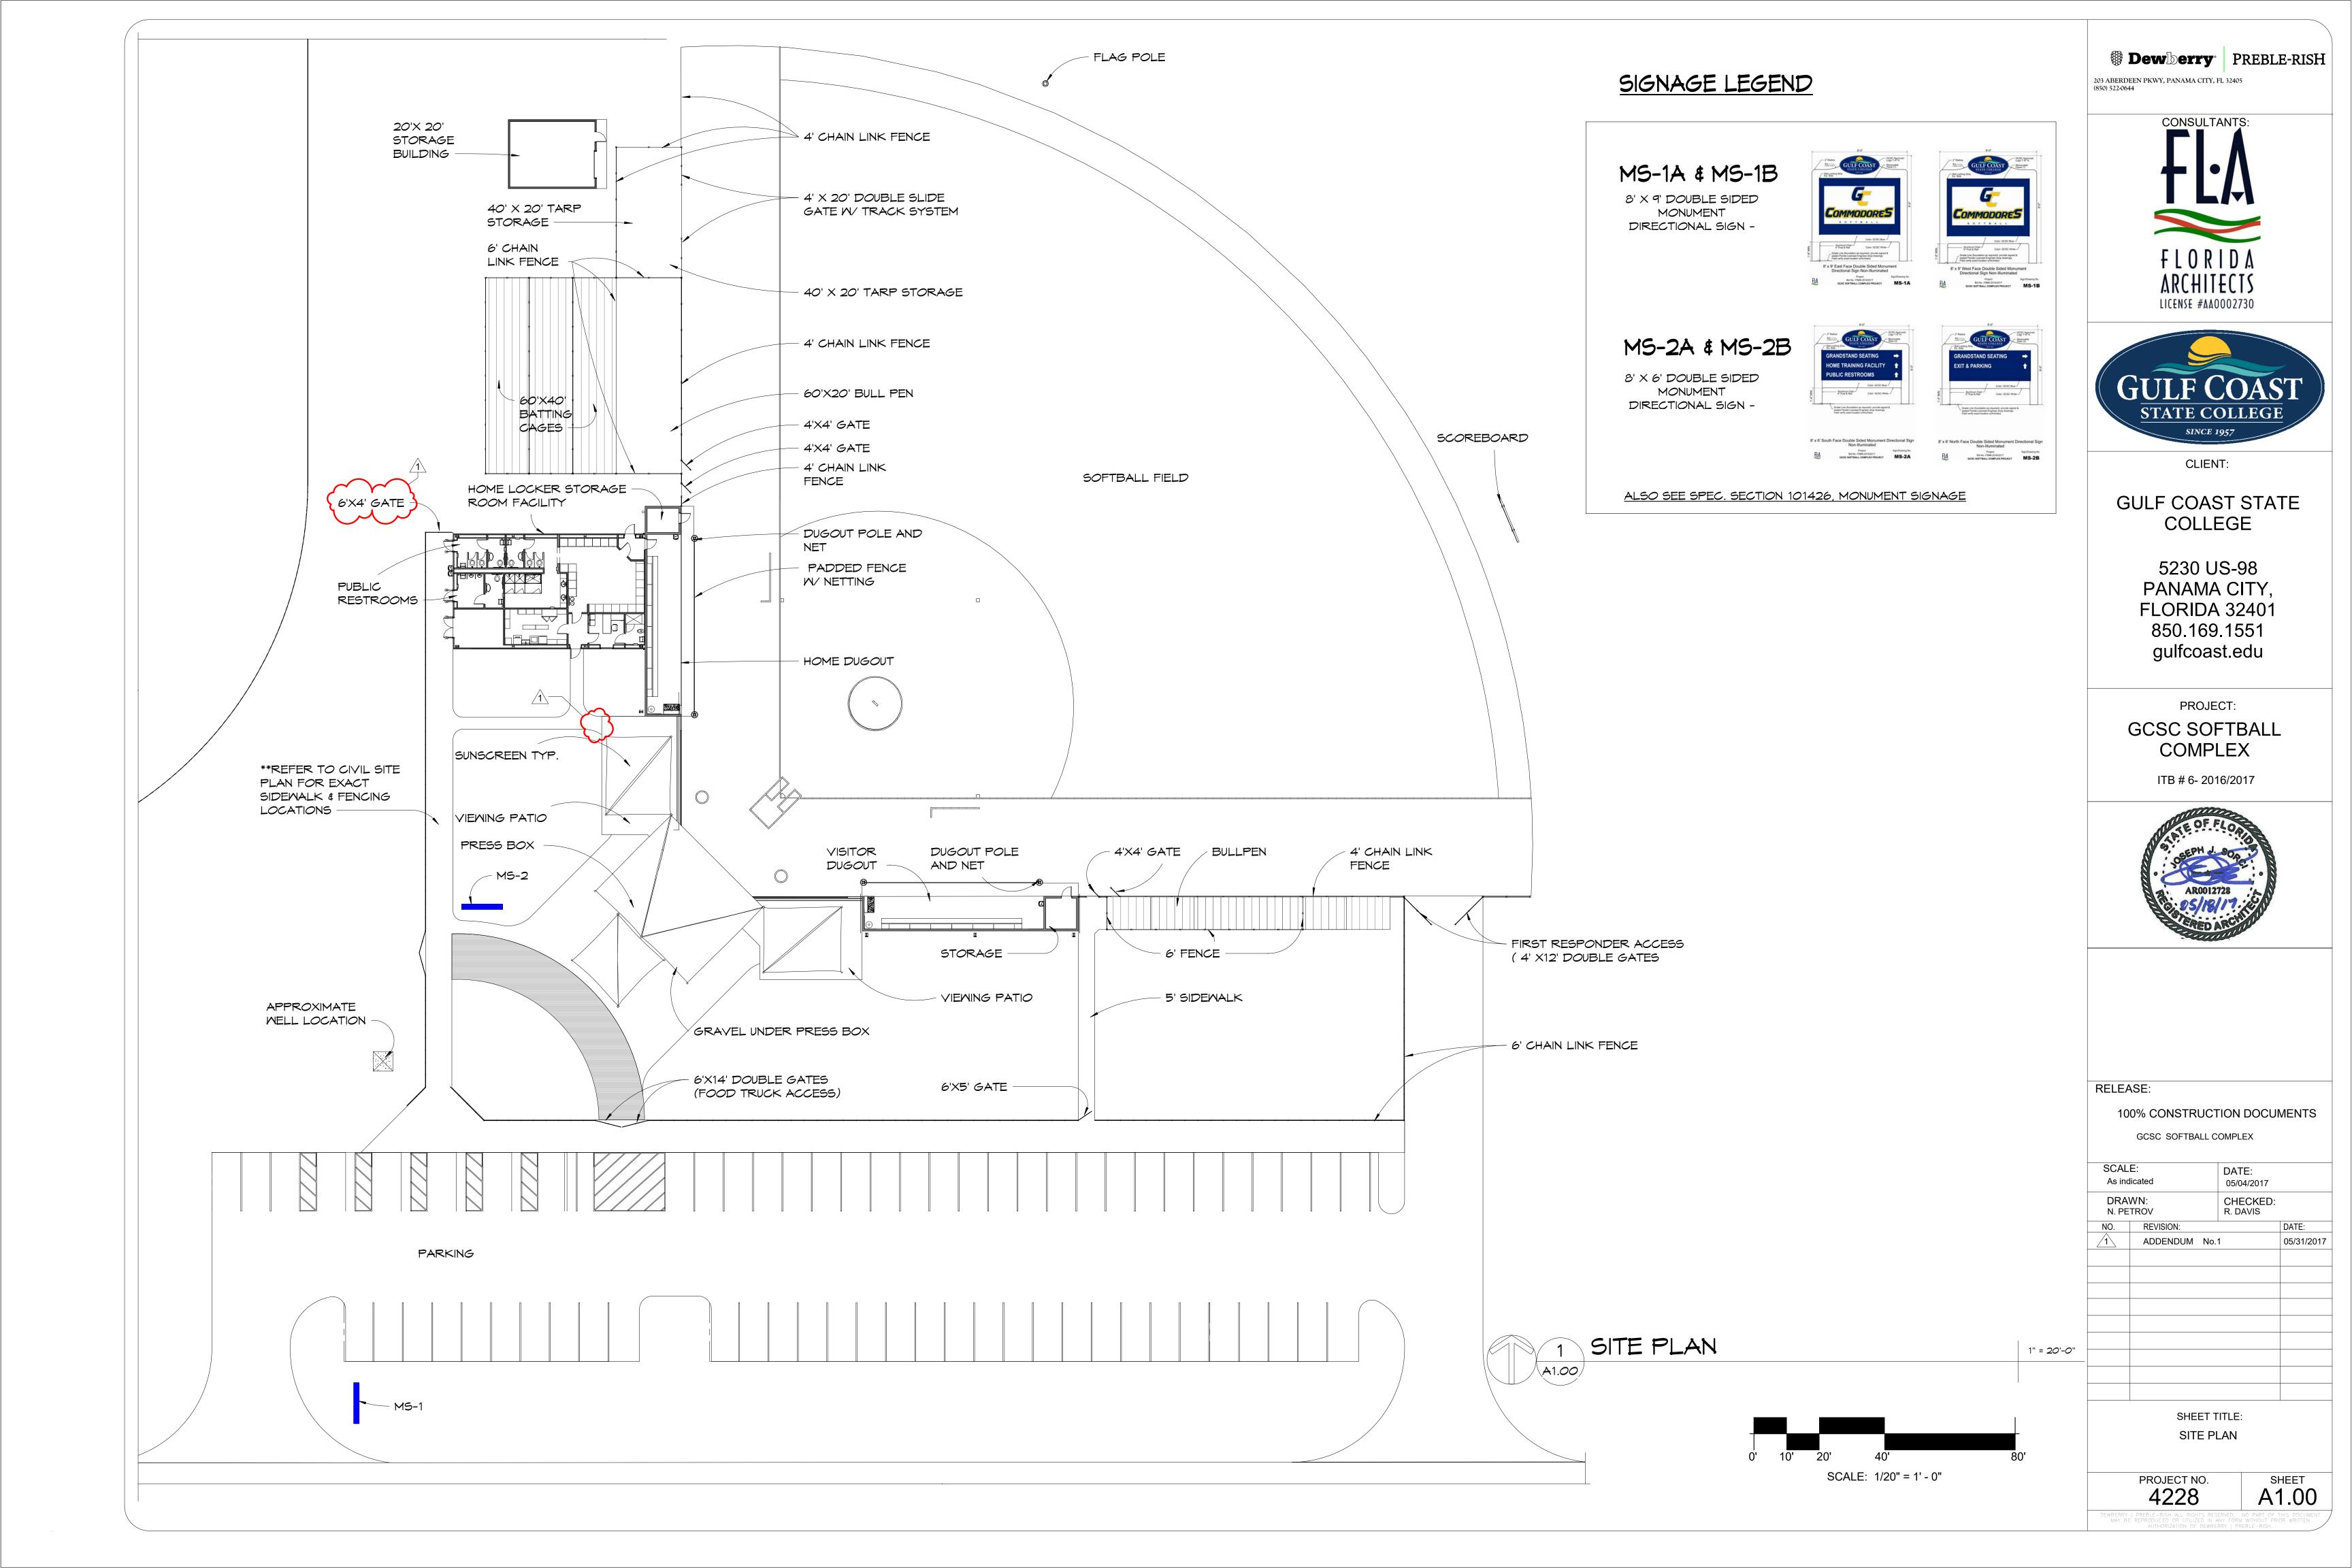

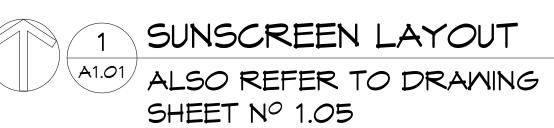

3/32" = 1'-0"

SHEET TITLE:
SUNSCREEN LAYOUT

RELEASE:

SCALE:

3/32" = 1'-0"

DRAWN: N. PETROV

NO. REVISION:

PROJECT NO. **4228** 

A1.01

**Dewberry** PREBLE-RISH

FLORIDA ARCHITECTS LICENSE #AAOOO2730

STATE COLLEGE

CLIENT:

**GULF COAST STATE** 

COLLEGE

5230 US-98

PANAMA CITY,

FLORIDA 32401

850.169.1551

gulfcoast.edu

PROJECT:

GCSC SOFTBALL

COMPLEX

ITB # 6- 2016/2017

100% CONSTRUCTION DOCUMENTS

DATE:

05/04/2017


CHECKED: R. DAVIS

05/31/2017

GCSC SOFTBALL COMPLEX

ADDENDUM No.1

203 ABERDEEN PKWY, PANAMA CITY, FL 32405 (850) 522-0644

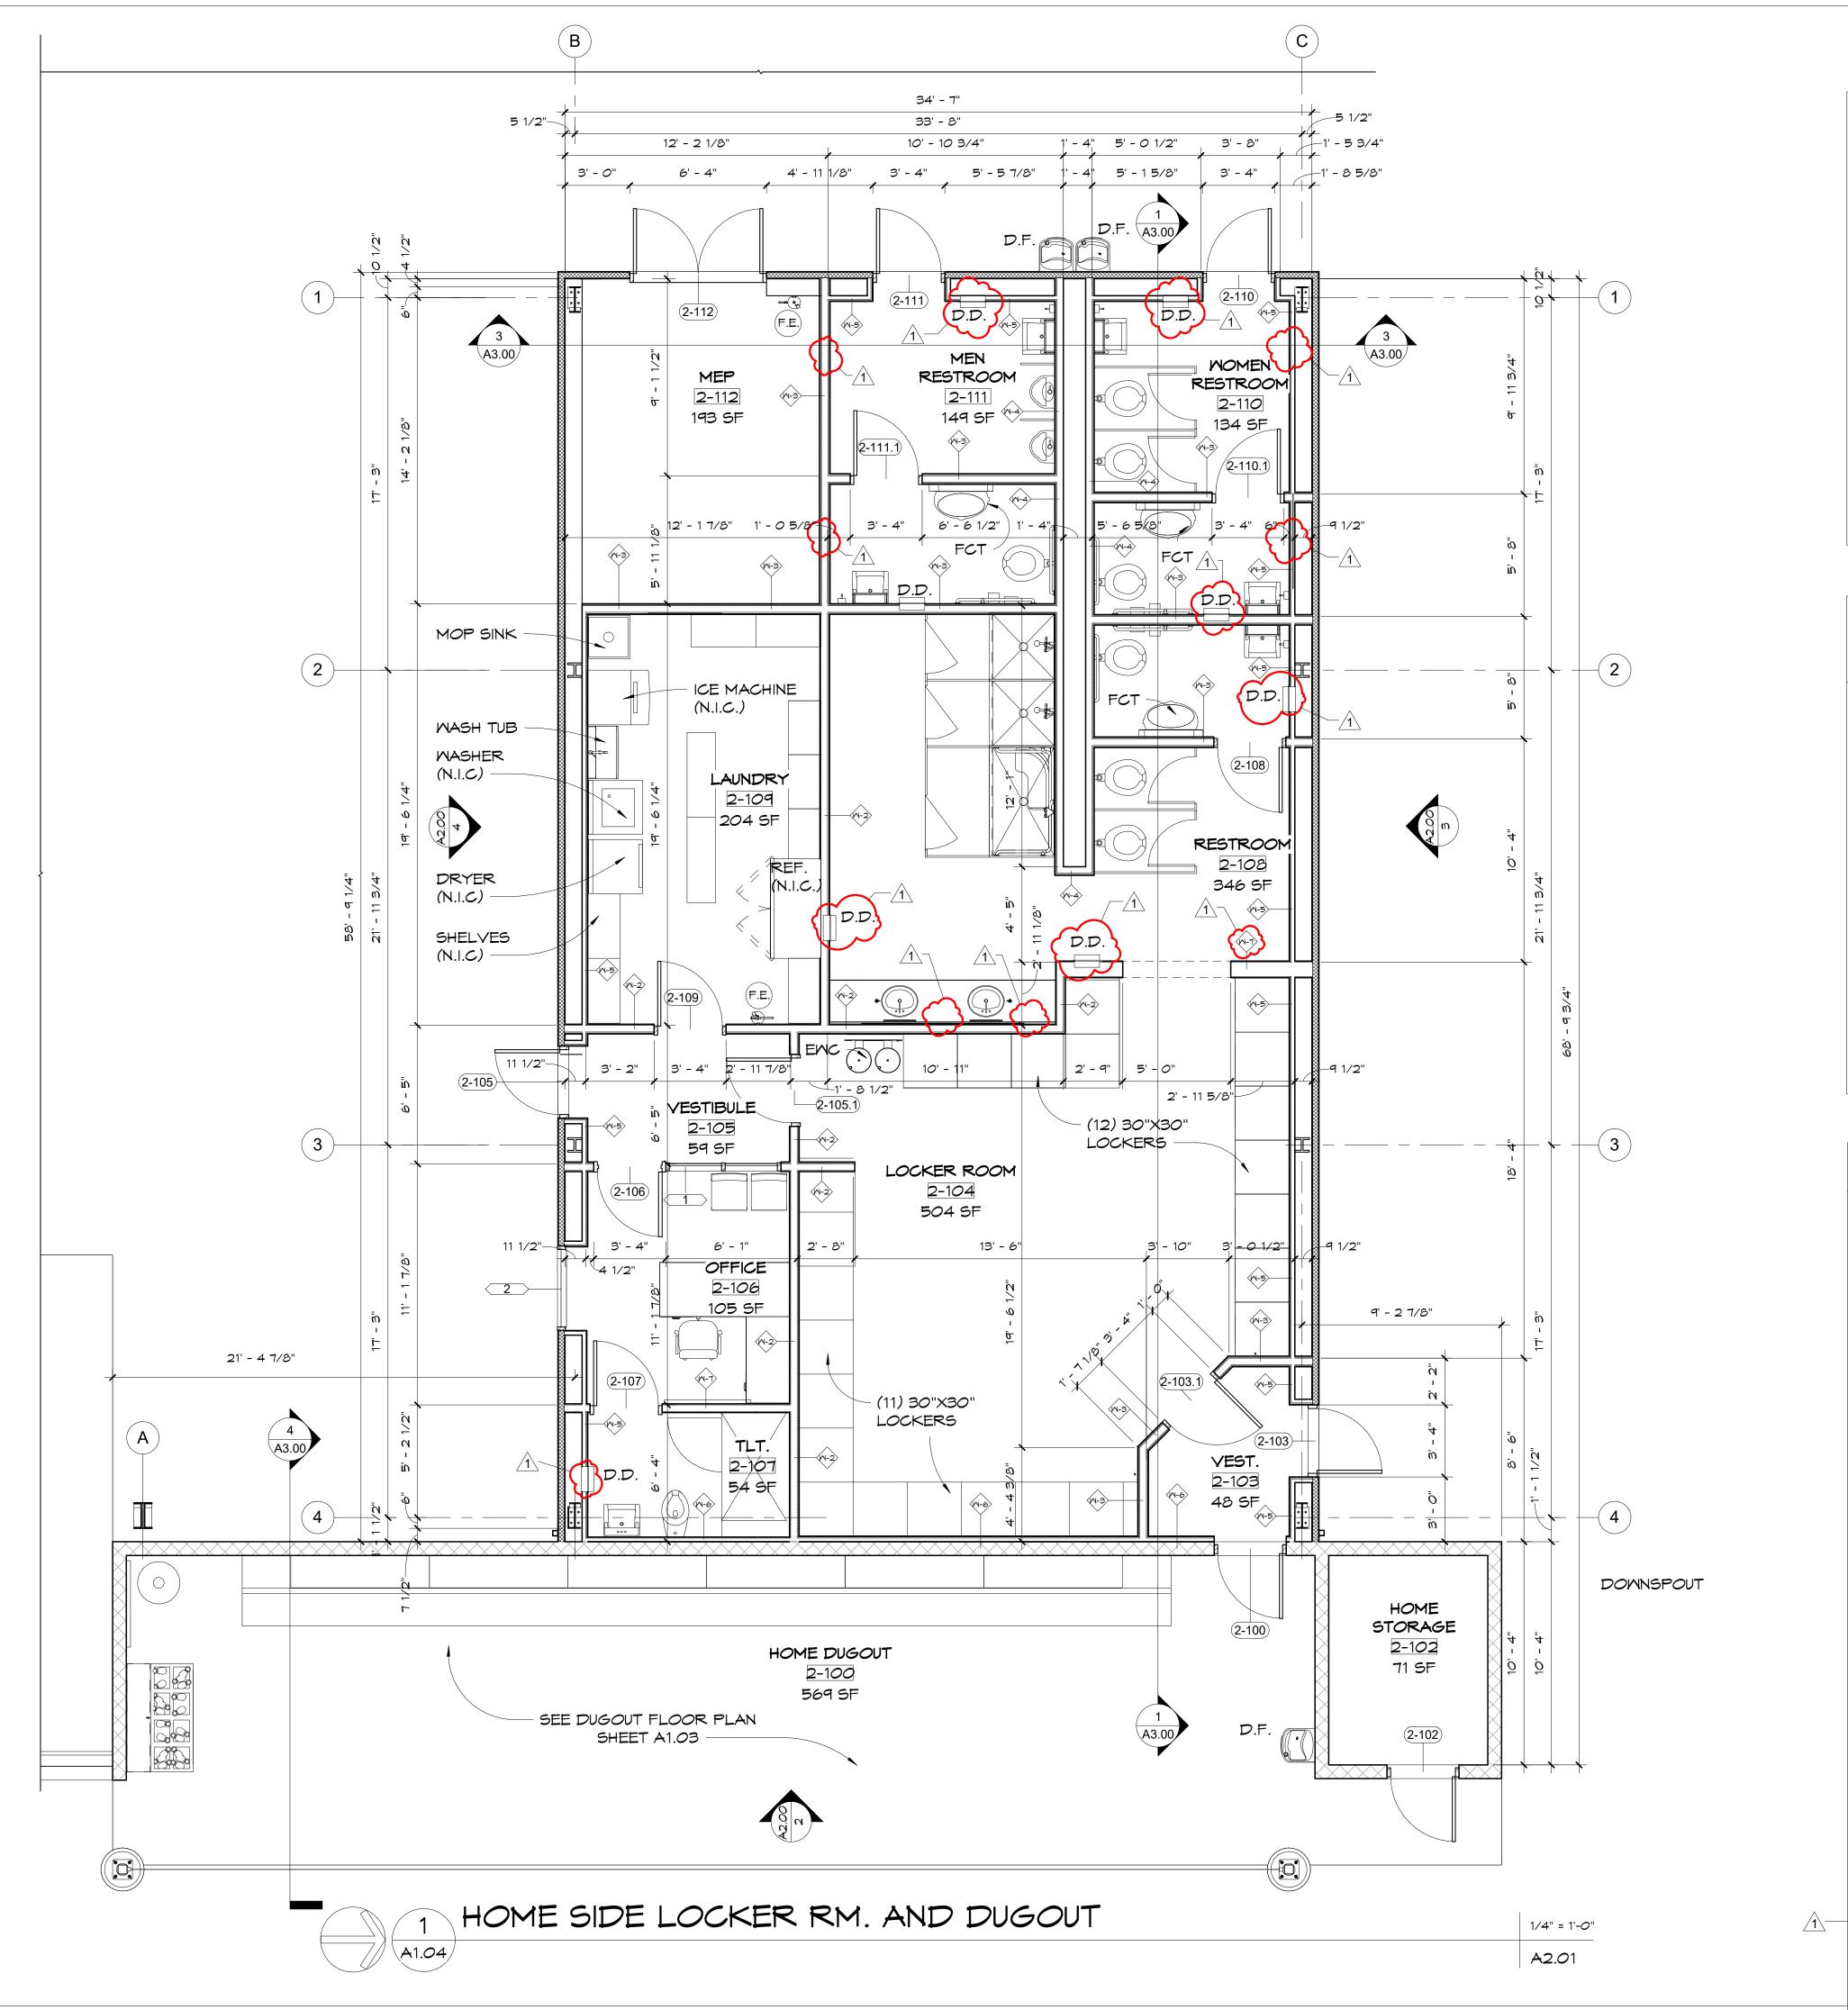

## GENERAL DIMENSION NOTES:

1. VERIFY ALL DIMENSIONS IN FIELD PRIOR TO START OF CONSTRUCTION.

2. VERIFY ALL FIELD CONDITIONS AND DIMENSIONS FOR COORDINATION OF ALL TRADES AND EQUIPMENT FROM VENDORS BEFORE CONSTRUCTION AND INSTALLATION.

3. DIMENSIONS TAKE PRECEDENCE OVER DRAWINGS. DO NOT SCALE DRAWINGS.

4. DIMENSIONS ARE FROM FACE OF METAL STUDS, CENTERLINE OF

COLUMNS OR NOMINAL FACE OF CONCRETE MASONRY. 5. INTERIOR STUD WALL DIMENSIONS ARE TAKEN FROM FACE OF METAL


6. GENERALLY, DOOR OPENINGS ARE LOCATED BY DIMENSION FROM

7. WINDOW HORIZONTAL DIMENSIONS ARE TAKEN FROM JAMB TO JAMB UNO. REFER TO WINDOW ELEVATION/ SCHEDULE FOR WINDOW ROUGH OPENING DIMENSIONS


8. ALL THRESHOLDS TO BE 1/2" (MAX.) IN HEIGHT.

## MATERIALS SYMBOLS (SECTION & DETAILS)

OUTSIDE OF JAMB TO OUTSIDEOF JAMB (ROUGH OPENING).

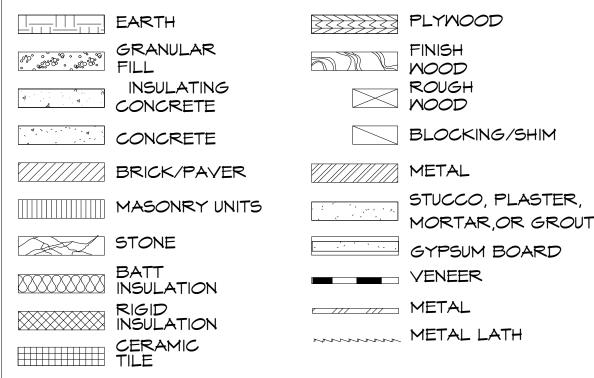

## GENERAL SYMBOLS

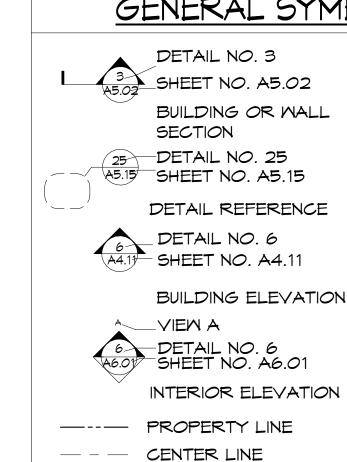

GLASS

ELEVATION NEW OR FINISH POINT ELEVATION EXISTING CONTOUR LINE

NEW OR FINISH CONTOUR LINE TB-1 TEST BORING LEVEL ELEVATION

EXISTING POINT

DATUM POINT REVISION NUMBER

FCT - FOLDING CHANGING

TABLE

COLUMN LINE REFERENCE

INDICATES MINDOM TYPE - KEYNOTE

NORTH ARROW TRUE NORTH NORTH ARROW

ABOVE

BREAK LINE

PLAN NORTH

HIDDEN LINE OR LINE

ROOM ROOM NAME 0-000 ROOM NUMBER PARTITION TYPE

DOOR NUMBER D.F. - DRINKING FOUNTAIN

ENC - ELECTRIC MATER COOLER FOUNTAIN

T.B. - RECESSED TRASH BIN

D.D. - SEMI- RECESSED DISPENSER/ DISPOSAL

**Dew**berry PREBLE-RISH

203 ABERDEEN PKWY, PANAMA CITY, FL 32405





CLIENT:

**GULF COAST STATE** COLLEGE

> 5230 US-98 PANAMA CITY, **FLORIDA 32401** 850.169.1551 gulfcoast.edu

> > PROJECT:

GCSC SOFTBALL COMPLEX

ITB # 6- 2016/2017



RELEASE:

SCALE:

100% CONSTRUCTION DOCUMENTS GCSC SOFTBALL COMPLEX

DATE:


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NO.	REVISION:		DATE:
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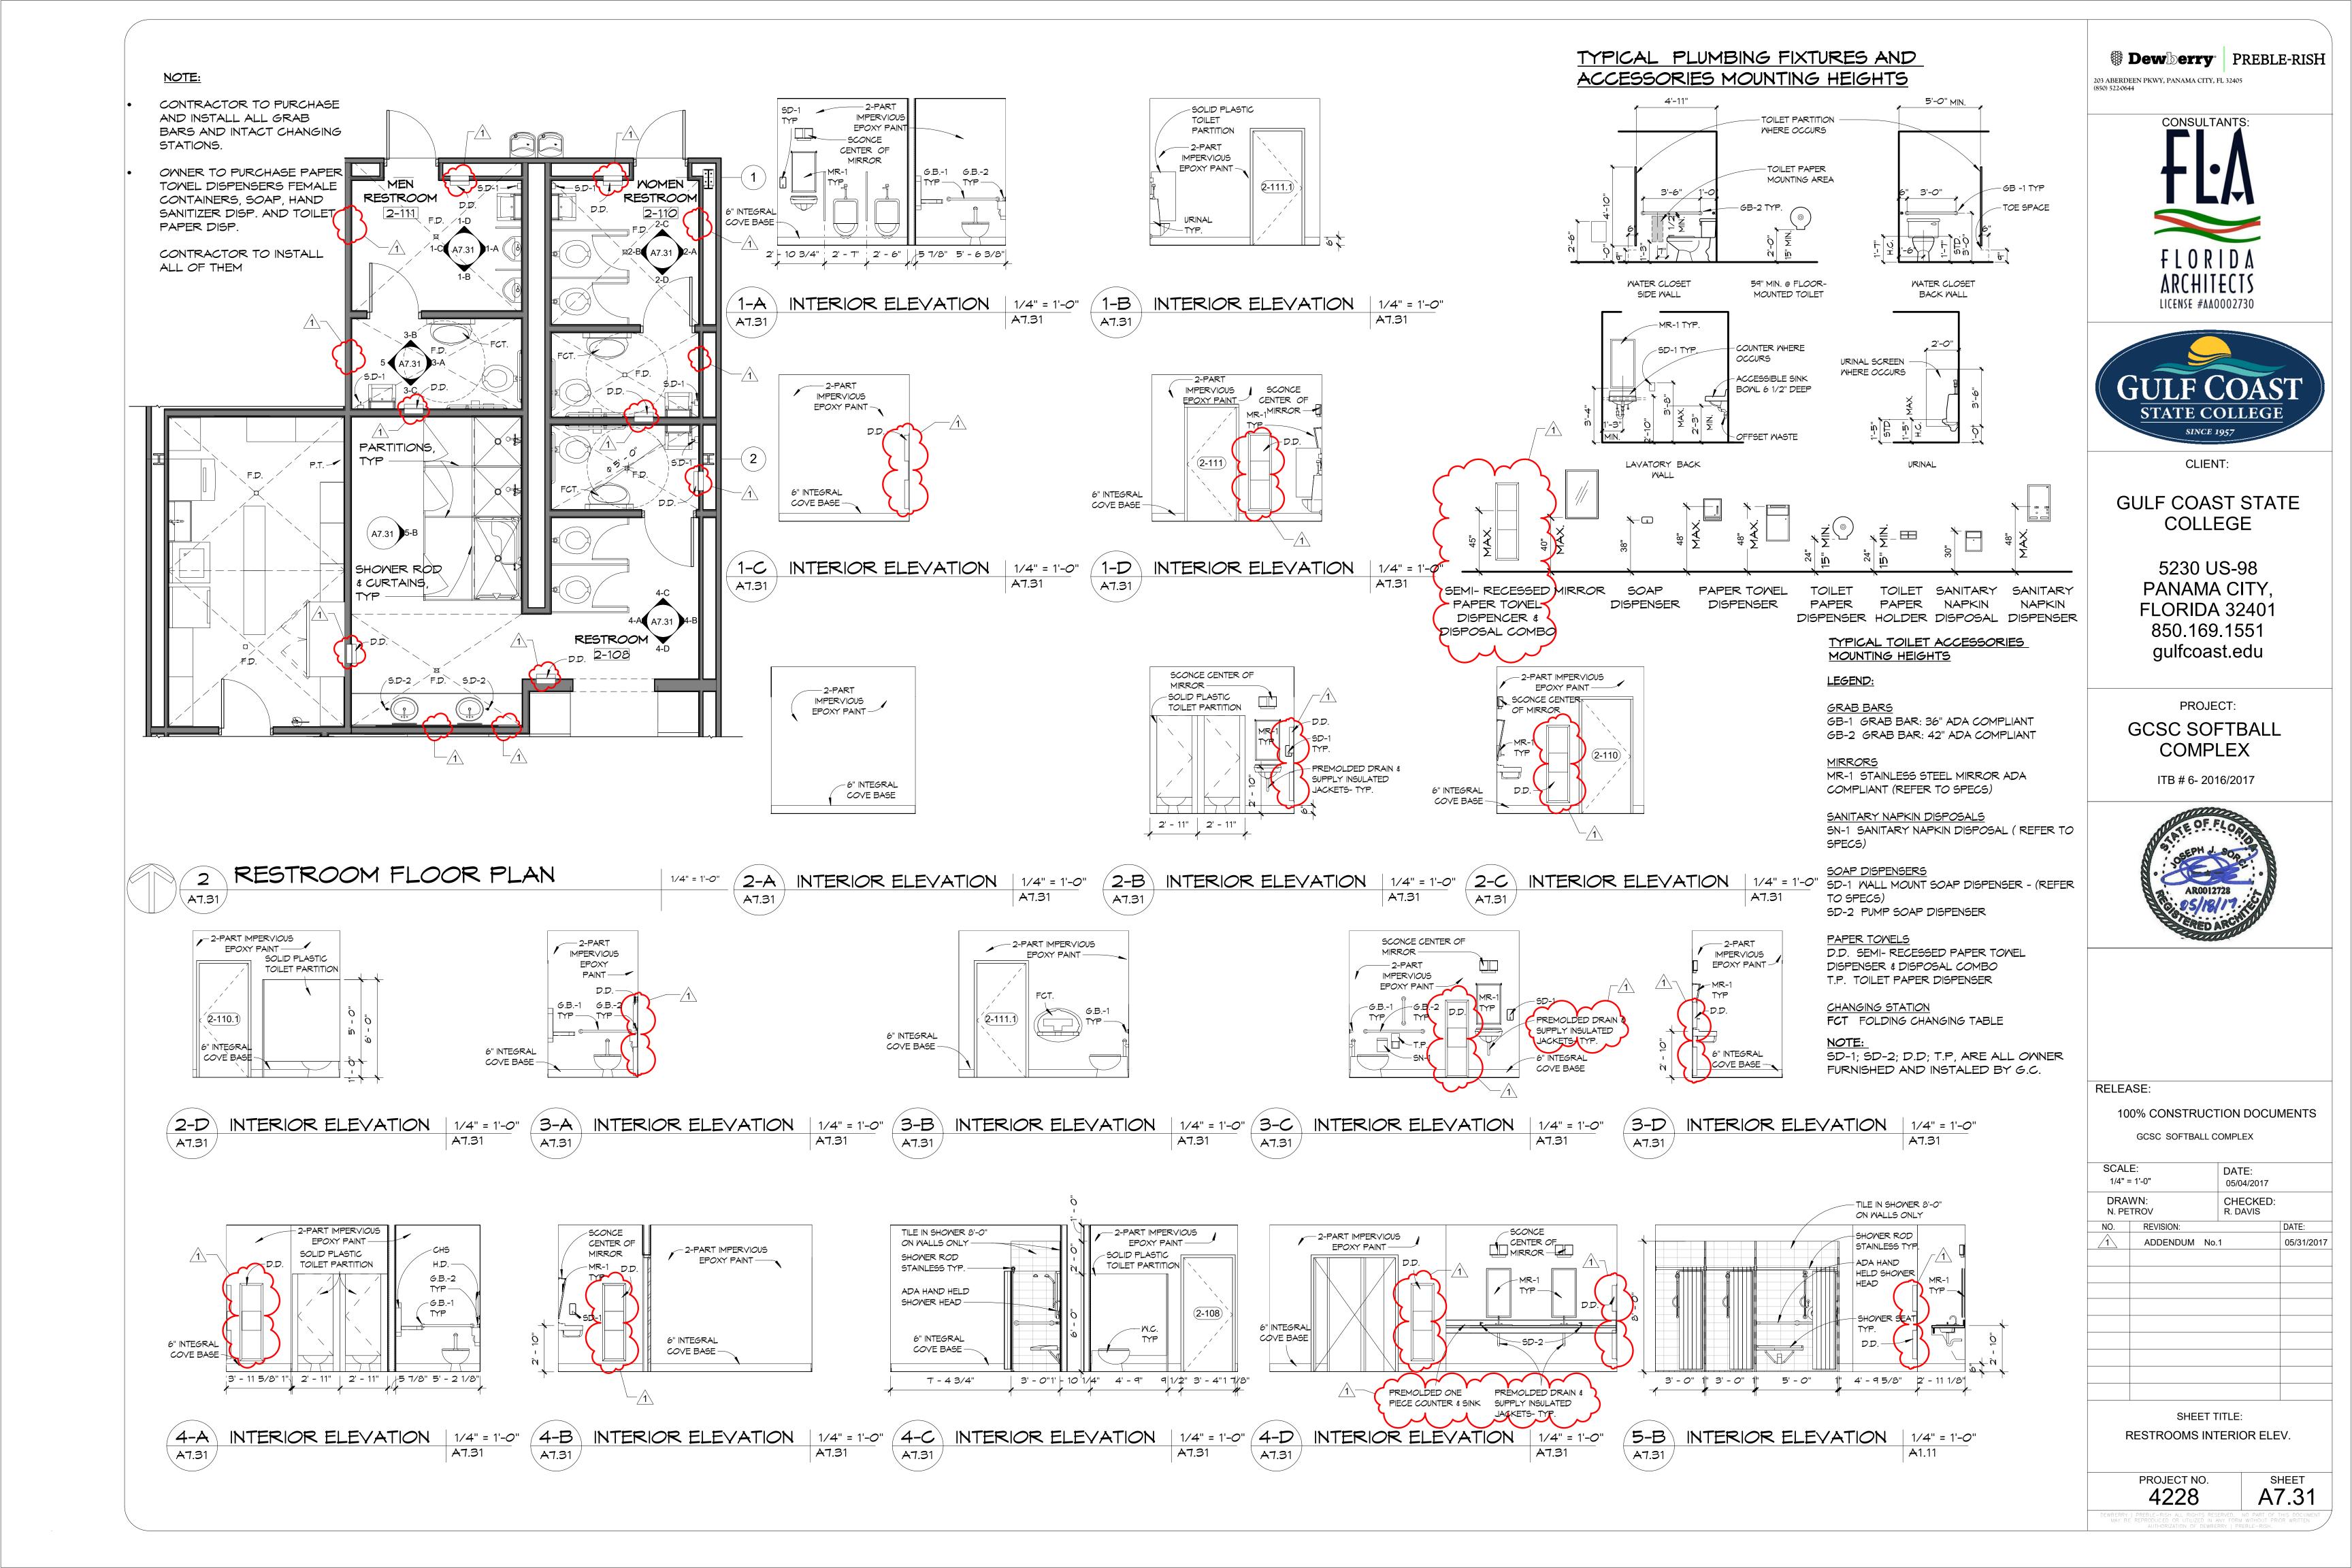
SHEET TITLE: HOME SIDE LOCKER RM. AND DUGOUT PLAN

PROJECT NO.

A1.04

SHEET



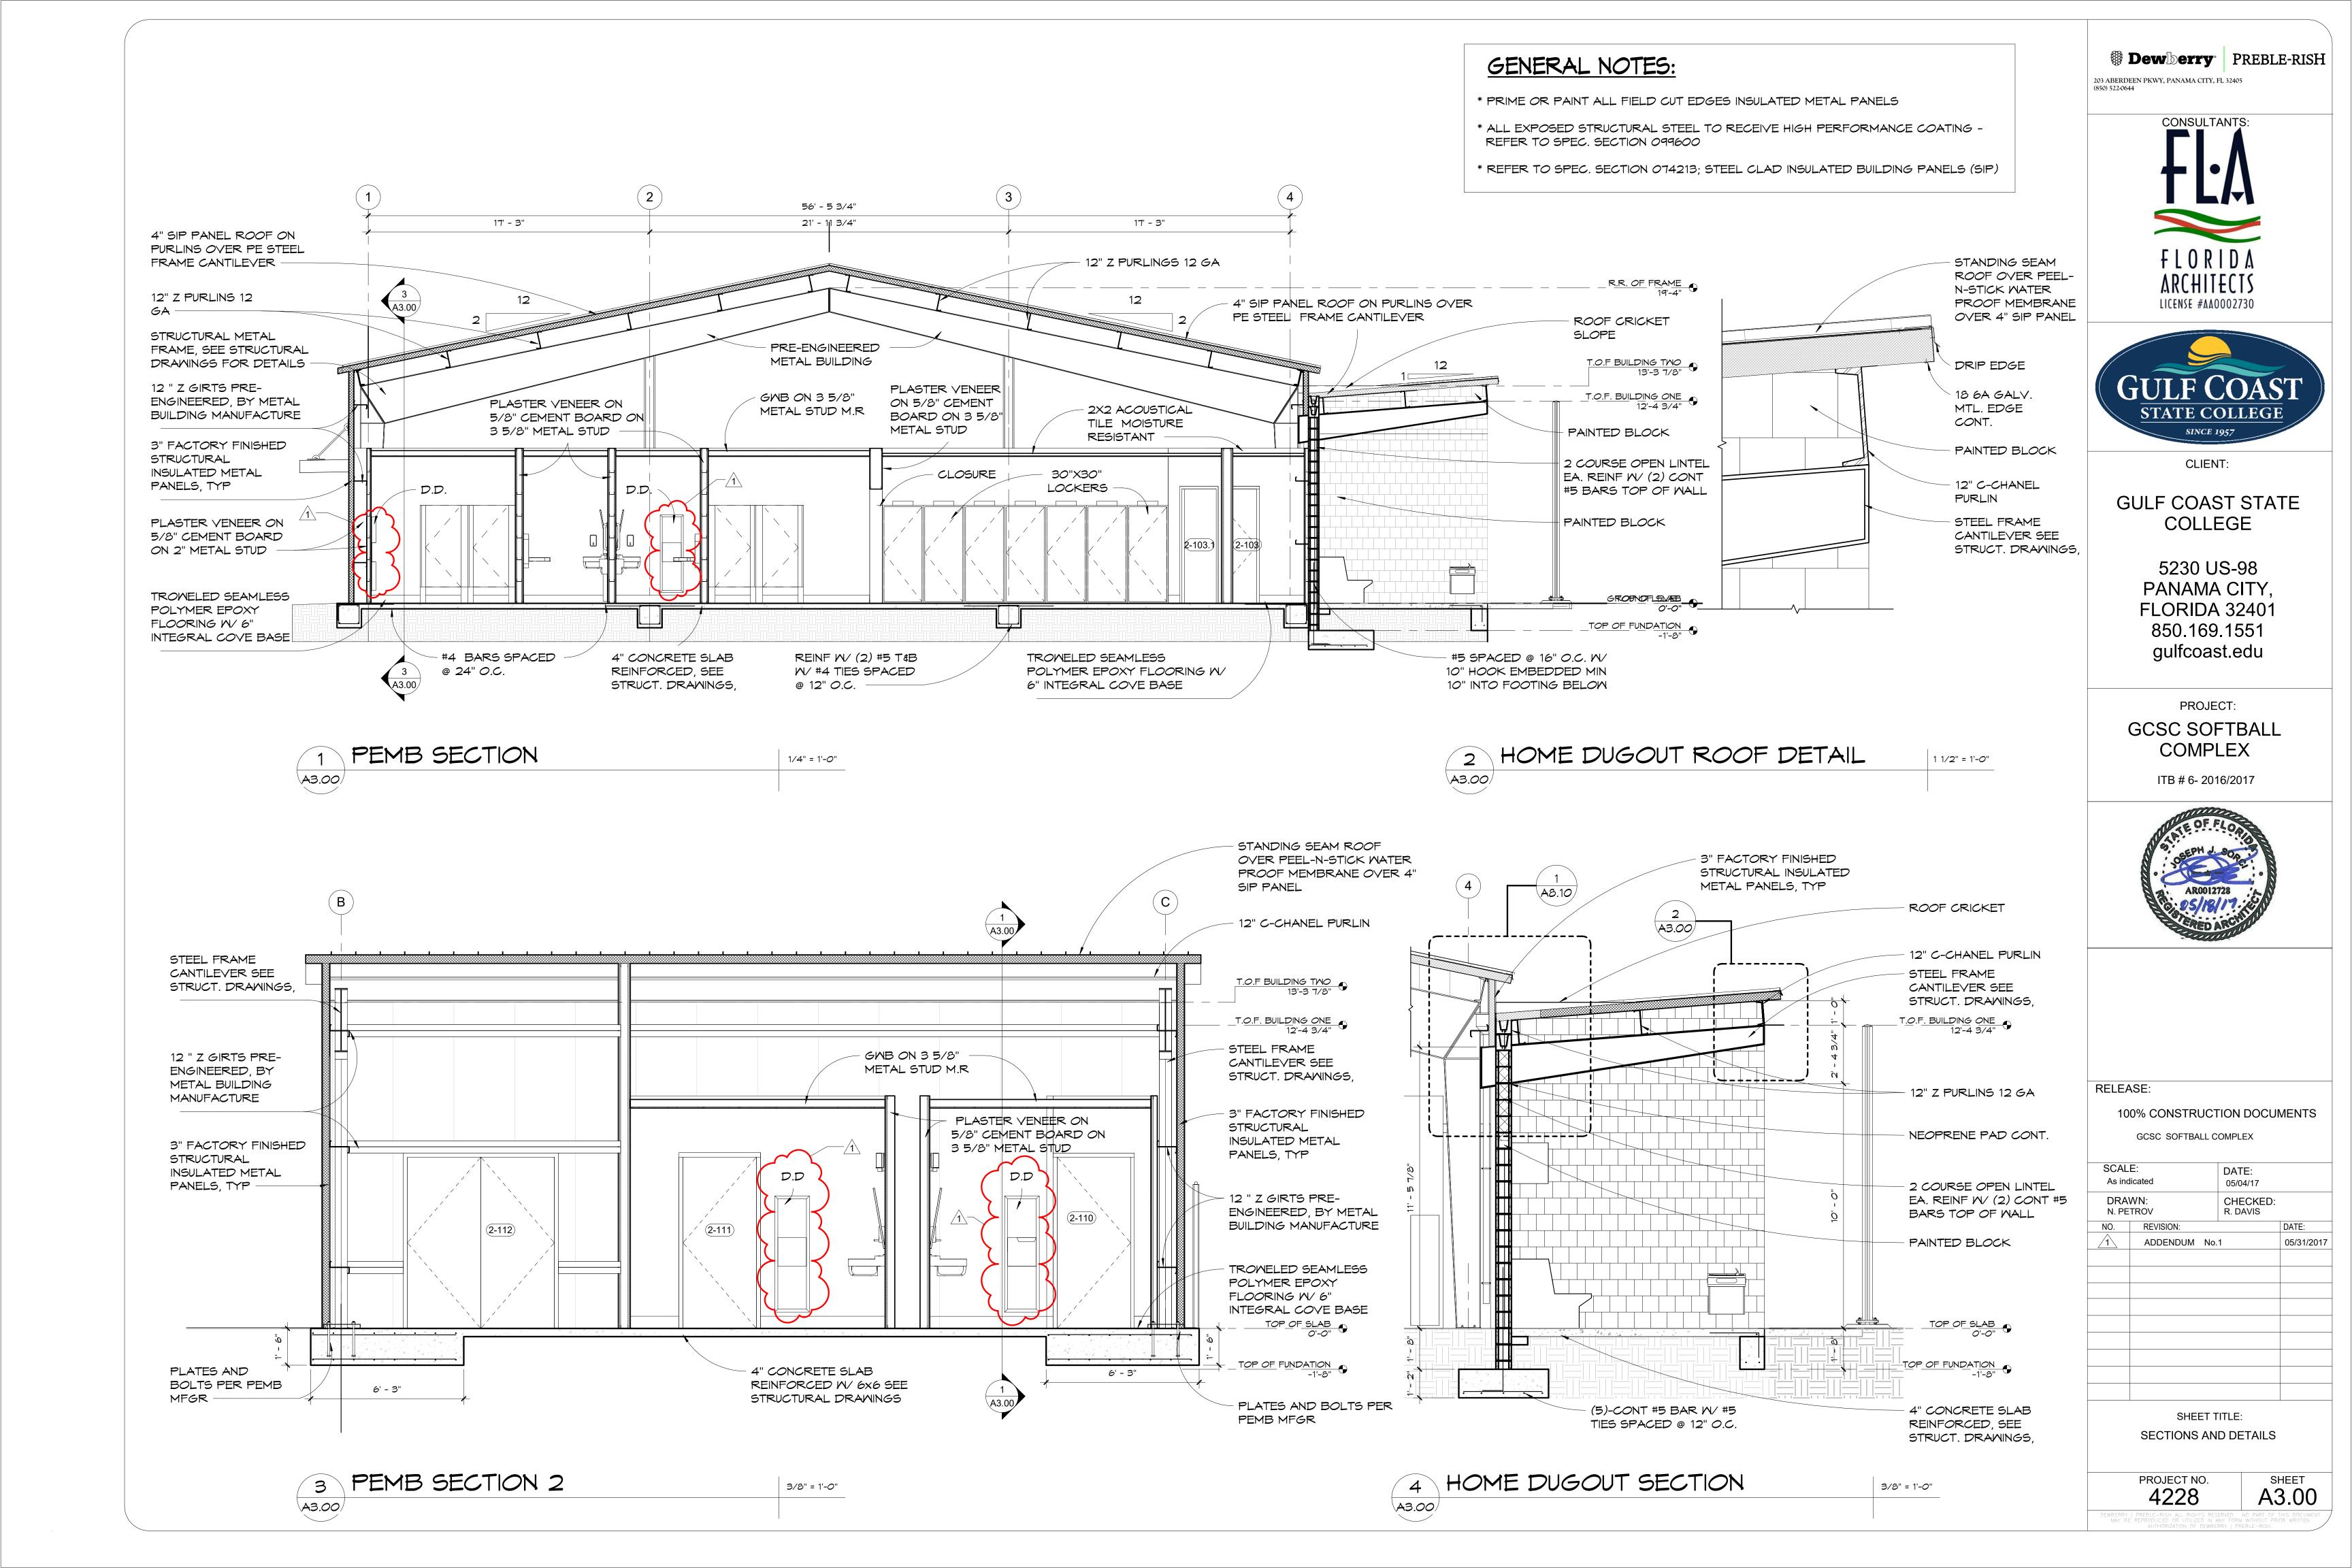

## DX SPLIT SYSTEM AIR TO AIR HEAT PUMP UNIT SCHEDULE

> [										· JI L	II SISILIV	1 / 1111	10 / 1110	112/11	. 014		JCI ILD								
					INDO	OR SECTION							UTDOOR SECTION			AHRI COOL	ING DATA (3)		AHRI HEATING I	DATA (3)	AU	XILIARY	HEATER DATA	4	
$\setminus \mid$	MARK LOCATI			EXTERNAL STATIO	A LIUVILION	ELECTRICAL	DATA(12	FILTER	DATA	C	COMPRESSOR	COND	DENSER FANS	ELECTRICAL	_	TOTAL MINIMUM	SENSIBLE MINIMUM	MINIMUM	MINIMUM HIGH AHRI RATING @		TUTA	_ NO. OF	ELECTRICA		_ KEMAKK2
$\rangle \mid$		AIR CFM	I	PRESSURE INCHES W.G.	FAN HORSEPOWER	VOLTS PHASE	Hz	MAXIMUM FACE VELOCITY - FPM	TYPE THICK	QUANTIT	MAXIMUM RATED LOAD AMPS EA.	QUANTITY	MAXIMUM FULL LOAD AMPS EA.	VOLTS PHASE	Hz	NET CAPACITY BTU/HR	NET CAPACITY BTU/HR	E.E.R.	CAPACITY BTU/HR	H.S.P.F.	ITPE KW	STEPS	VOLTS PHAS	Æ Hz	
<b>&gt;</b> [	HP-I SEE PL	ANS 2,665	5 640	0.75 (1)	1.5	460 3	60	330	2 1"	2	6.1	1	1.6	460 3	60	84,660	63,740	12.5	85,070	7.7	4 15.0	1	460 3	60	56789011234

## SPLIT SYSTEM HEAT PUMP UNIT NOTES:

- (1) DOES NOT INCLUDE PRESSURE DROP THROUGH FILTERS OR ELECTRIC RESISTANCE HEATER.
- (2) DISPOSABLE
- (3) E.E.R. ENERGY EFFICIENCY RATIO. RATED IN ACCORDANCE WITH AIR CONDITIONING, HEATING, AND REFRIGERATION INSTITUTE (AHRI) STANDARD 340/360 AT AHRI STANDARD CONDITIONS.
- (4) ELECTRIC RESISTANCE. KW INDICATED IS RATED AT VOLTAGE INDICATED.
- (5) PROVIDE REMOTE CONDENSING UNIT WITH COIL
- (6) REFRIGERANT PIPING SIZE, ROUTING, AND CONFIGURATION SHALL BE AS RECOMMENDED BY MANUFACTURER OF HEAT PUMP UNIT. INSULATE ENTIRE LENGTH OF EACH SUCTION LINE WITH MINIMUM 3/4" THICK UNICELLULAR FOAM INSULATION.
- (7) PROVIDE REMOTE CONDENSING UNITS WITH FACTORY ANTI-SHORT CYCLE (TIME DELAY ON RESTART) CONTROLS.
- (8) CONDENSATE PIPE SHALL BE I" SCHD. 80 PVC. TRAP AT UNIT AND ROUTE TO FLOOR DRAIN. CONSTRUCT ALL TRAPS FROM TEES WITH A CAP ON EACH TEE.
- (9) ROUTE REFRIGERANT AND CONDENSATE PIPING TO ALLOW CONVENIENT ACCESS TO HEAT PUMP INDOOR UNIT FOR SERVICING. ALLOW A MINIMUM OF 3'-0" IN FRONT OF ALL ACCESS PANELS.
- (10) BASIS OF DESIGN TRANE MODEL TWA090E4 REMOTE HEAT PUMP UNIT WITH DUAL COMPRESSORS AND TRANE MODEL TWE090 INDOOR UNIT OR APPROVED EQUALS.
- (II) PROVIDE UNITS WITH PHASE PROTECTION.
- (12) UNITS AND CONTROLS SHALL BE SETUP SUCH THAT THE ELECTRICAL HEAT IS THE SECOND STAGE OF HEAT AND IS LOCKED OUT ANY TIME (4) PROVIDE UNIT WITH RAWAL THE UNIT IS IN DEFROST MODE.
- (B) PROVIDE FACTORY COIL COATING ON CONDENSER COIL TO PREVENT CORROSION.
  - APR DEVICE ON LEAD COMPRESSOR.

	FAN SCHEDULE																			
								PERFORMANCE D	ATA		ELE	CTRICAL	DATA	TA .						
MARK	TYPE 1	DRIVE 2	SERVICE 3	LOCATION	CONTROL	INTERLOCKS	AIR FLOW	EXTERNAL STATIC PRESS. INCHES WC			MINIMUM HORSEPOWER	VOLTS	PHASE	HERTZ	REMARKS					
EF-107	CEF	DD	EA	SEE PLANS	DDC SYSTEM	6	70	0.25	778	1.1	30.2 WATTS	120	1	60	COOK MODEL GC-146	45				
EF-108	CEF	DD	EA	SEE PLANS	DDC SYSTEM	6	210	0.25	1,065	5.0	88.9 WATTS	120	1	60	COOK MODEL GC-186	45				
EF-110A	CEF	DD	EA	SEE PLANS	DDC SYSTEM	6	100	0.25	889	1.5	37.9 WATTS	120	1	60	COOK MODEL GC-148	45				
EF-110B	CEF	DD	EA	SEE PLANS	DDC SYSTEM	6	50	0.25	671	0.8	25.0 WATTS	120	1	60	COOK MODEL GC-128	45				
EF-111A	CEF	DD	EA	SEE PLANS	DDC SYSTEM	6	100	0.25	889	1.5	37.9 WATTS	120	1	60	COOK MODEL GC-148	45				
EF-111B	CEF	DD	EA	SEE PLANS	DDC SYSTEM	6	50	0.25	671	0.8	25.0 WATTS	120	1	60	COOK MODEL GC-128	45				

## FAN SCHEDULE NOTES:

- ① CEF CEILING EXHAUST FAN
- ② DD DIRECT DRIVE
- ③ EA EXHAUST AIR 4) PROVIDE FAN WITH A SPEED
  - CONTROLLER FOR AIR FLOW BALANCING. MOUNT CONTROLLER WITHIN FAN HOUSING.
- ⑤ PROVIDE MANUFACTURER AND MODEL LISTED OR BY GREENHECK OR PENN ARE ACCEPTABLE, PROVIDED THAT THEY MEET ALL RÉQUIREMENTS SPECIFIED FOR FANS MANUFACTURED BY LOREN COOK.
- (6) INTERLOCK EXHAUST FANS AND OUTSIDE AIR DAMPER FOR HP-I TO BE ENERGIZED DURING OCCUPIED PERIODS.

	MINI-SPLIT SYSTEM AIR CONDITIONING UNIT SCHEDULE																									
	INDOOR SECTION DUTDOOR SECTION											•	ARI COOLING	DATA(3)												
MARK	TOTAL OUTSIDE FAN ELECTRICAL DATA									SOUND PRESSURI			SOUND PRESSURE	ELECTRICAL DATA				TOTAL MINIMUM MINIMU	MINIMUM	REMARKS						
	1	1		1			AIR CFM HI-LO	AIR CFM	F.L.A	MINIMUM AMPACITY	MAXIMUM FUSE SIZE	VOLTS/	PHASE	E/HZ	FILTER DATA	LEVEL dB(A)	<u></u>	LEVEL dB(A)	MINIMUM AMPACITY	MAXIMUM FUSE SIZE	VOLTS	/PHASI	E/HZ	TOTAL MINIMUM NET CAPACITY BTU/HR	S.E.E.R.	
MS-1		713-403	0	1	_	-	230	1	60	FACTORY STANDARD	49		54	18.3	20	230	1	60	18,000	18.0	4567					

## MINI-SPLIT SYSTEM AIR CONDITIONER UNIT NOTES:

- ① DAIKIN FTXI8NMVJU WALL MOUNTED INDOOR UNIT. PROVIDE WITH FACTORY OPTIONAL CONDENSATE PUMP. PROVIDE WITH FACTORY STANDARD WIRELESS REMOTE CONTROLLER. INSTALL UNIT IN STRICT ACCORDANCE WITH AT ARI STANDARD CONDITIONS MANUFACTURER'S PRINTED INSTRUCTION MANUAL. RUN ALL PIPING AND CONDUIT CONCEALED. CONTRACTOR SURVEY SITE AND VERIFY ALL CONDITIONS RELATIVE TO MOUNTING EQUIPMENT.
  - (2) DAIKIN RXI8NMVJU OUTDOOR CONDENSING UNIT.

(3) RATED IN ACCORDANCE WITH ARI STANDARD 210/240

- S.E.E.R. = SEASONAL ENERGY EFFICIENCY RATIO E.E.R. = ENERGY EFFICIENCY RATIO
- 4 PROVIDE REMOTE CONDENSING UNIT WITH COIL
- 5 PROVIDE REMOTE CONDENSING UNIT WITH FACTORY ANTI-SHORT CYCLE (TIME DELAY ON RESTART)
- 6 REFRIGERANT PIPING SIZE, ROUTING, AND CONFIGURATION SHALL BE AS RECOMMENDED BY MANUFACTURER OF AIR CONDITIONING UNIT. MAXIMUM TOTAL LENGTH OF REFRIGERANT PIPING SHALL BE 98 FEET PER MANUFACTURER'S SPECIFICATIONS FOR RXI8NMVJU UNIT.
- TREFRIGERANT PIPING SIZE, ROUTING, AND MINIMUM 3/4" THICK UNICELLULAR FOAM INSULATION.

## GENERAL DDC NOTES

ALL DDC WORK TO BE DONE IN SEPERATE CONTRACT.

CONFIGURATION SHALL BE AS RECOMMENDED BY MANUFACTURER OF HEAT PUMP UNIT. INSULATE ENTIRE LENGTH OF EACH SUCTION LINE WITH

**Dewberry** PREBLE-RISH 203 ABERDEEN PKWY, PANAMA CITY, FL 32405 (850) 522-0644





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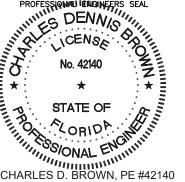
GULF COAST STATE COLLEGE

> 5230 US-98 PANAMA CITY, FLORIDA 32401 850.169.1551 gulfcoast.edu

> > PROJECT:

GCSC SOFTBALL COMPLEX





RELEASE:

SCALE:

CONSTRUCTION DOCUMENTS

SCAL As inc	E: dicated	DATE: 05/04/2017	
DRA R. J. I	WN: PICKERING	CHECKED: C. D. BROWN	
NO.	REVISION:	•	DATE:
1	ADDENDUM No. 1		6-1-


SHEET TITLE:

HVAC SCHEDULES **AND NOTES** 

PROJECT NO. 4226

SHEET

M2

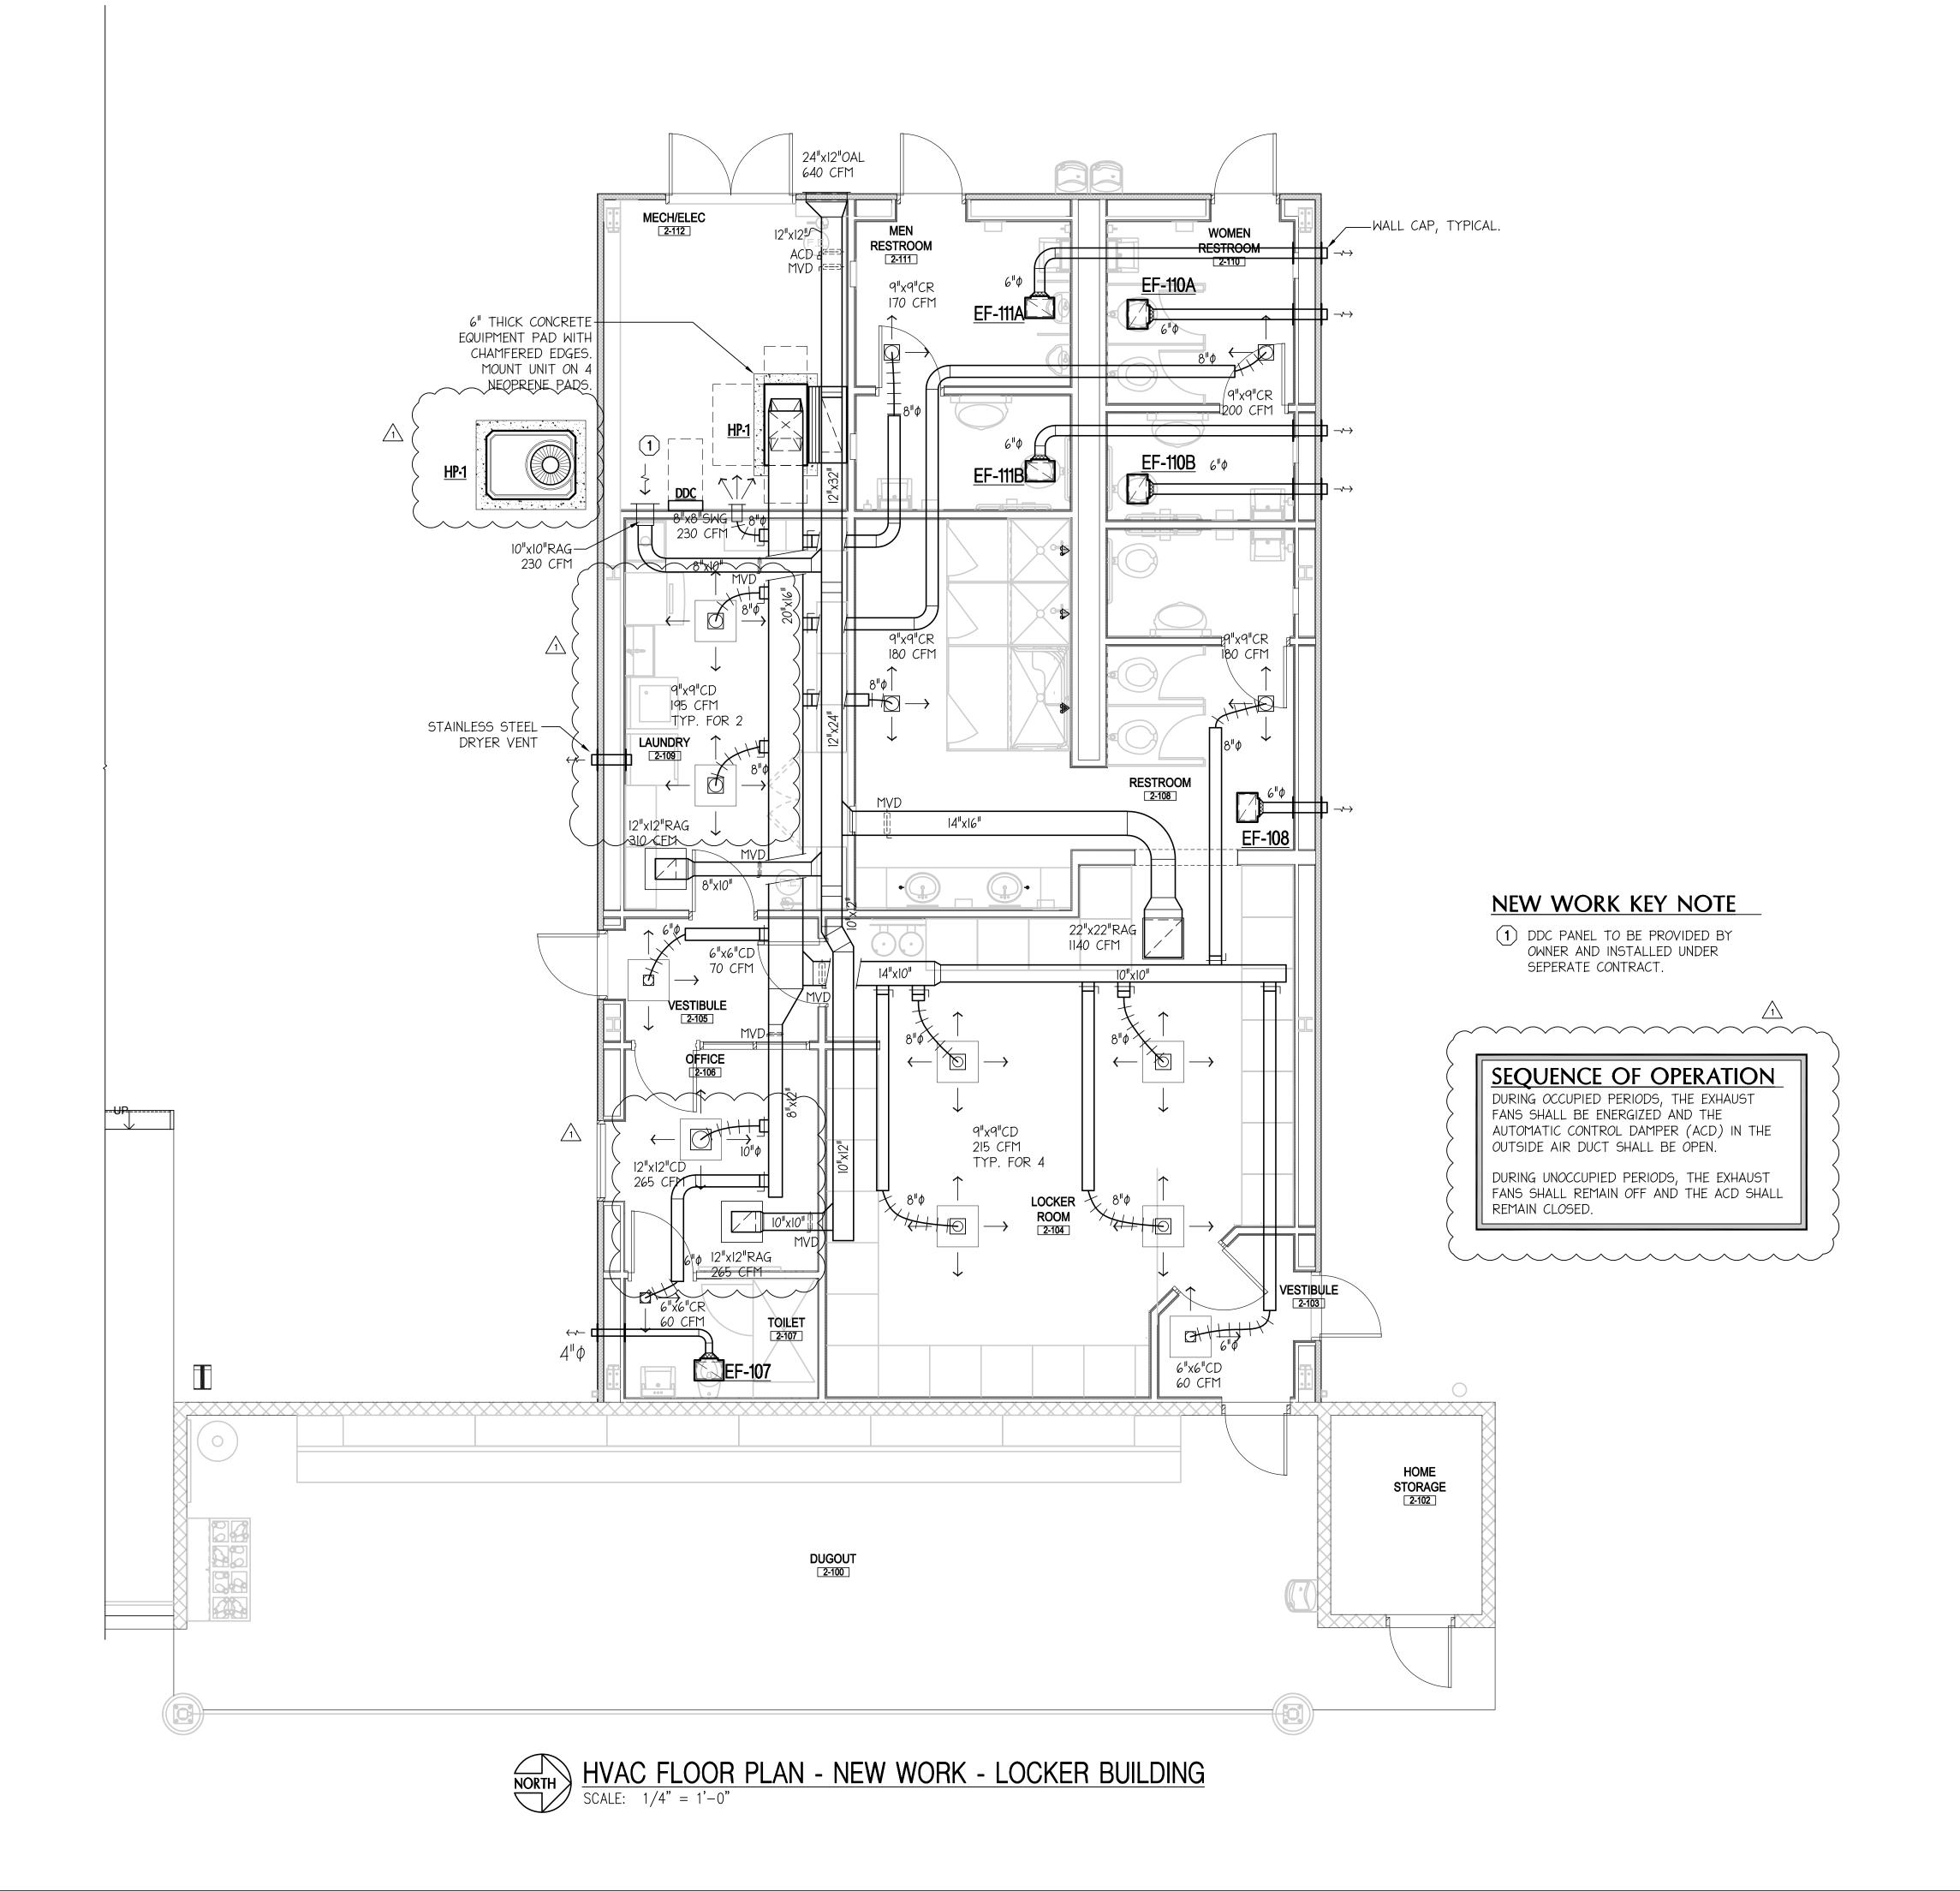

Dewberry PREBLE-RISH

203 ABERDEEN PKWY, PANAMA CITY, FL 32405
(850) 522-0644





CLIENT:


## GULF COAST STATE COLLEGE

5230 US-98 PANAMA CITY, FLORIDA 32401 850.169.1551 gulfcoast.edu

PROJECT:

GCSC SOFTBALL COMPLEX



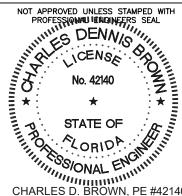

CHARLES D. BROWN, PE #421
RELEASE:

CONSTRUCTION DOCUMENTS

SCAL As inc	E: dicated	DATE: 05/04/2017	
DRA' R. J. I	WN: PICKERING	CHECKED: C. D. BROWN	
NO.	REVISION:		DA
1	ADDENDUM No. 1		6-

SHEET TITLE:

HVAC FLOOR PLAN - NEW WORK

PROJECT NO. **4226** 

SHEET M3

## General Plumbing Notes:

- I. THE CONTRACTOR SHALL EXECUTE WORK SO THAT IT PROCEEDS WITH A MINIMUM INTERFERENCE WITH OTHER TRADES.
- 2. VERIFY EXACT PLUMBING FIXTURE ROUGH-IN AND FINAL HVAC EQUIPMENT REQUIREMENTS IN THE FIELD.
- 3. THE CONTRACTOR SHALL BE RESPONSIBLE FOR FINAL CONNECTIONS TO PLUMBING FIXTURES. THIS RESPONSIBILITY INCLUDES, BUT IS NOT LIMITED TO, FURNISHING AND INSTALLING TRAPS, DRAINS, AND SUPPLIES WITH STOPS. FURNISH AND INSTALL PLUMBING FIXTURES INDICATED OR SPECIFIED, COMPLETE WITH EQUIPMENT, FITTINGS, TRIM AND ACCESSORIES INDICATED OR SPECIFIED. EXPOSED WATER PIPING TO FIXTURES SHALL BE CHROME-PLATED BRASS, IPS. ADJUST WATER FLOW THROUGH FIXTURES TO PROVIDE PROPER FLUSHING ACTION WITH THE LEAST AMOUNT OF WATER. FAUCETS SHALL HAVE UNDERDECK AND/OR ESCUTCHEON PLATES, IF REQUIRED, TO STABILIZE FAUCET WITHIN FIXTURE.
- 4. COORDINATE ROUTING OF WATER SUPPLY, WASTE, & VENT PIPING WITH OTHER TRADES.
- 5. THE PLUMBING CONTRACTOR SHALL COORDINATE WITH THE GENERAL CONTRACTOR AND OTHER TRADES REQUIRED OPENINGS AND EXCAVATIONS.
- 6. ITEMS PROJECTING THROUGH THE ROOF/WALL SHALL BE FLASHED A MINIMUM OF 12" ABOVE THE ROOF. VENTS SHALL BE A MINIMUM OF 10 FEET FROM ANY OUTSIDE AIR INTAKE. COAT EXPOSED VENT PIPING W/ UV RESISTANT PAINT, COLOR BY ARCHITECT.
- 7. ACCESS PANEL: WHERE FITTINGS REQUIRING MAINTENANCE OR ISOLATION VALVES ARE LOCATED ABOVE NON-ACCESSIBLE CEILINGS OR SOFFITS (EXAMPLE PLASTER, METAL, OR GYPSUM BOARD), INSTALL AN ACCESS DOOR IN CEILING DIRECTLY BELOW EACH SUCH FITTING/VALVE. ACCESS DOORS SHALL BE AS DESCRIBED IN SPECIFICATIONS.
- 8. FLOOR DRAIN/SINK SPECIAL NOTE: IN SPACES WHERE FLOOR DRAINS/SINKS ARE SHOWN, DRAINS SHALL BE SET AT LOW POINTS OF FLOOR WITH GRADUAL AND EVEN FLOOR SLOPE TO DRAIN. POCKETS IN THE FLOOR SHALL NOT BE ALLOWED AROUND FLOOR DRAINS/SINKS. PRIOR TO SETTING FLOOR DRAIN/SINK ELEVATIONS, THE PLUMBING CONTRACTOR SHALL REVIEW THE FLOOR SLOPES SHOWN ON THE ARCHITECTURAL AND STRUCTURAL DRAWINGS, AND SHALL CLOSELY COORDINATE TOP OF DRAIN ELEVATIONS WITH THE GENERAL CONTRACTOR AND THE FLOOR SLAB INSTALLER. LIQUIDS SHALL POSITIVELY FLOW TO FLOOR DRAINS/SINKS IN EACH LOCATION - STANDING WATER AT ANY POINT SHALL NOT BE ACCEPTABLE. COORDINATE FINAL LOCATION & ELEVATION WITH ARCHITECT PRIOR TO ROUGH-IN. PATCH EXISTING FLOOR TO MATCH SURROUNDING AFTER INSTALLATION OF FLOOR DRAINS.
- 9. ALL FLOOR DRAINS & FLOOR SINKS NOT RECEIVING SINK FIXTURE DRAINAGE SHALL HAVE A 4" DEEP SEAL AND TRAPS WITH TRAP PRIMERS AS REQUIRED BY CODE. CONTRACTOR TO ENSURE THAT EACH FLOOR DRAIN/SINK DOES NOT EXTEND ABOVE THE ADJACENT FLOOR SURFACE. INSTALL AN ACCESS PANEL FOR TRAP PRIMER FITTINGS LOCATED INSIDE A WALL NO TRAP PRIMERS ABOVE CEILING SYSTEM. EACH TRAP PRIMER TO HAVE A SHUTOFF BALL VALVE UPSTREAM. COORDINATE OPENINGS WITH ARCHITECT. CONTRACTOR MAY INSTALL WATER CLOSET FLUSH VALVE OR LAVATORY TYPE PRIMER FITTINGS TO SERVE RESTROOM FLOOR DRAINS. INSTALL IN AN INCONSPICUOUS UNOCCUPIED LOCATION (BELOW COUNTERTOP MOUNTED LAVATORY, CUSTODIAL OR MECHANICAL ROOM). CONTRACTOR TO ENSURE THAT EACH TRAP PRIMER VALVE IS CLEANED AND FREE OF DEBRIS JUST PRIOR TO PROJECT COMPLETION.
- 10. PROVIDE STOPS AND SHOCK ABSORBERS IN ACCORDANCE WITH PDI AND ASSE 1010. AN ACCESS PANEL MUST BE INSTALLED IF WATER HAMMER ARRESTOR IS LOCATED INSIDE A WALL OR ABOVE A HARD CEILING. COORDINATE OPENINGS WITH ARCHITECT.
- II. PROVIDE AN ACCESS PANEL IF ISOLATION/SHUTOFF VALVE OR FITTING REQUIRING MAINTENANCE IS LOCATED INSIDE A WALL OR ABOVE A HARD CEILING. VALVES/SERVICABLE FITTINGS SHALL BE LOCATED WITHIN REACH OF ACCESS DOOR OR LAY-IN CEILING SYSTEM (18" MAX.). COORDINATE OPENINGS WITH ARCHITECT. MARK CEILING TILES AS REQUIRED PER SPECIFICATIONS.
- 12. PROVIDE DIELECTRIC UNIONS AT DISSIMILAR METAL CONNECTIONS.
- 13. INSULATE DOMESTIC WATER AND WASTE PIPING UNDER LAVATORIES AND SINKS USING "LAVGUARD2 E-Z SERIES" MOLDED VINYL PIPING COVERS. COVER PIPING, FITTING, VALVES, AND TRAPS EXPOSED TO VIEW.
- 14. ROUTE PIPING AS HIGH AS POSSIBLE AND SO AS TO CAUSE MINIMAL INTERFERENCE FOR MAINTENANCE OF ALL EQUIPMENT. UNLESS OTHERWISE NOTED, NEW WATER SUPPLY PIPING IS ROUTED ABOVE THE CEILING AND BELOW ATTIC/ROOF INSULATION. BRANCH PIPING SHALL BE ROUTED WITHIN WALL CAVITY. PATCH WALLS TO MATCH SURROUNDING.
- 15. PROVIDE SHUTOFF VALVE TO EACH SILLCOCK WITH VALVE IDENTIFICATION AS REQUIRED BY CODE.
- 16. P-TRAPS SHALL BE 17-GAGE CAST BRASS.
- 17. FIRE-STOP PIPE PENETRATIONS OF FIRE AND SMOKE RATED ENCLOSURES. SEE ARCHITECTURAL DWGS. AND COORDINATE WITH ARCHITECT AND GENERAL CONTRACTOR IN THE
- 18. PVC WILL NOT BE ALLOWED IN RETURN AIR PLENUMS.
- 19. COORDINATE FINAL LOCATION OF HUB DRAINS, FLOOR DRAINS, AND FLOOR SINKS IN THE FIELD WITH THE EQUIPMENT SUPPLIERS.
- 20. DRAIN PIPING FROM INDIVIDUAL EQUIPMENT ROUTED TO THE HUB/FLOOR DRAIN/SINK SHALL BE HARD PIPED COPPER UNLESS OTHERWISE NOTED.
- 21. COORDINATE HOT WATER, COLD WATER, & WASTE CONNECTIONS TO FIXTURES PROVIDED BY EQUIPMENT SUPPLIERS, INCLUDING ANY NECESSARY FITTINGS SUCH AS PRESSURE REDUCING VALVES, VACUUM BREAKERS, WATER HAMMER ARRESTERS, SHUTOFF VALVES, ETC. COORDINATE REQUIREMENTS WITH THE EQUIPMENT SUPPLIER IN THE FIELD. PROVIDE FITTINGS FOR A COMPLETE INSTALLATION WHETHER SPECIFICALLY SHOWN OR NOT.
- 22. MARK CEILING GRID AT VALVES & EQUIPMENT AS DIRECTED BY OWNER. CLEAR LABELING/BLACK CHARACTERS WITH ADHESIVE BACKING SHALL BE APPLIED TO CEILING GRID BELOW EACH VALVE. IN ADDITION, LABEL ROOM TYPE & FLOOR SERVED ON INSULATION ADJACENT TO BALL VALVE ABOVE CEILING.

## Plumbing Legend:

BREAKER & LOOSE KEY OPERATOR.

HOSE BIBB WITH VACUUM BREAKER

WASTE PIPING. SIZED AS SHOWN. WCO WALL CLEANOUT CIRCULATION PUMP. SEE SCHEDULE THIS SHEET. —————— WASTE VENT PIPING. SIZED AS SHOWN. FCO FLOOR CLEANOUT ELECTRIC WATER HEATER. SEE SCHEDULE AND INSTALLATION DETAIL. COLD WATER PIPING. SIZED AS SHOWN. GCO GROUND CLEANOUT PLUMBING FIXTURE NUMBER. SEE HD HUB DRAIN. SIZED AS SHOWN. SCHEDULE ON THIS SHEET. —— -- —— HOT WATER RETURN PIPING. SIZED AS SHOWN. FLOOR DRAIN W/ FLUSH STRAINER. OUTLET SIZE AS AIR ADMITTANCE VALVE SHOWN. ZURN 415 'TYPE B' OR APPROVED EQUAL. ABOVE FINISHED FLOOR FLOOR DRAIN W/ 7" DIA. RECESSED STRAINER. INSTALL FLUSH W/ FINISHED BALL VALVE FOR SHUT-OFF SERVICE. FLOOR. OUTLET SIZE AS SHOWN. ZURN 415 'TYPE I' OR APPROVED EQUAL N.O. NORMALLY OPEN FLOOR DRAIN W/ SQUARE STRAINER. OUTLET SIZE AS SHOWN. BALANCING VALVE. TOUR \$ ANDERSSON NORMALLY CLOSED ZURN 415 'TYPE S' (6"x6") OR APPROVED EQUAL. MODEL STAD OR APPROVED EQUAL. EX. EXISTING FLOOR SINK W/ HALF GRATE & BEEHIVE STRAINER. OUTLET CHECK VALVE. SIZE AS SHOWN. ZURN 1900 OR APPROVED EQUAL. SS STAINLESS STEEL 3/4" EXPOSED FREEZEPROOF WALL HYDRANT WITH VACUUM STAINLESS STEEL FLOOR SINK W/ HALF GRATE & BEEHIVE STRAINER. W/ WITH BREAKER OUTLET SIZE AS SHOWN. ZURN 1751 OR APPROVED EQUAL. 3/4" CHROME PLATED HOSE BIBB WITH VACUUM VTR VENT THROUGH ROOF. SIZED AS SHOWN.

			C	ONNECTION	S	
MARK #	FIXTURE TYPE	MANUFAC. & MODEL	WASTE	CW	HW	REMARKS
P-1	WATER CLOSET (ADULT)	ZURN Z5655	3"	1111	-	FLOOR MOUNTED, ELONGATED WATER CLOSET, SLOAN REGAL MANUAL FLUSH VALVE W/ SPLIT RING PIPE SUPPORT, & ZURN Z5955SS-EL OPEN FRONT SEAT WITHOUT COVER. (1.6 GPF)
P-IA	WATER CLOSET (ADULT - HC)	ZURN Z5665	3"	1"	-	FLOOR MOUNTED, ELONGATED WATER CLOSET, SLOAN REGAL MANUAL FLUSH VALVE W/ SPLIT RING PIPE SUPPORT, & ZURN Z5955SS-EL OPEN FRONT SEAT WITHOUT COVER. (HC) (1.6 GPF)
P-2	WALL MOUNTED URINAL	ZURN Z5798	2"	3/4"	-	VIT. CHINA, CARRIER WALL MOUNTED, SLOAN REGAL MANUAL FLUSH VALVE W/ SPLIT RING PIPE SUPPORT. (0.125 GPF) <u>SEE ARCH. DWGS. FOR ADA LOCATIONS</u> .
P-3	WALL MOUNTED LAVATORY	ZURN Z5344	1-1/4" X 1-1/2"	1/2"	1/2"	VIT. CHINA, PROVIDE WITH CONCEALED ARMS SUPPORT AND T\$\$ BRASS B-0831-WA VANDAL RESISTANT WRISBLADE HANDLE METERING FAUCET, I.O GPM AERATOR, OFFSET TRAP AND STRAINER. PROVIDE POINT OF USE MIXING VALVE FOR LAVATORY. MOUNT BELOW FIXTURE AND ADJUST VALVE TO NOT EXCEED 110°F. (HC)
P-4	COUNTERTOP MOUNTED LAVATORY	FITTINGS ONLY	1-1/4" X 1-1/2"	1/2"	1/2"	INTEGRAL LAVATORY COUNTERTOP WITH T&S BRASS B-0831-WA VANDAL RESISTANT WRIST BLADE HANDLE METERING FAUCET, I.O GPM AERATOR, GRID STRNR., & OFFSET P-TRAP. PROVIDE POINT OF USE MIXING VALVE FOR LAVATORY. MOUNT BELOW FIXTURE AND ADJUST VALVE TO NOT EXCEED 110°F. SEE ARCH.
P-5	SHOWER	FITTINGS ONLY	2"	1/2"	1/2"	LEONARD 76-IA SHOWER SYSTEM W/ PRESSURE BALANCING MIXING VALVE & 1.5 GPM ADJ. METAL SHOWER HEAD. STAINLESS STEEL HORIZONTAL GRAB BAR, SHOWER CURTAIN & ROD, & VINYL FLEXIBLE DAM. DRAIN ASSEMBLY SHALL BE COMPATIBLE W/ SHOWER BASE, WHICH INCLUDES STAINLESS STEEL STRAINER, CLAMPING COLLAR, & SEEPAGE SLOTS.
P-5A	SHOWER (HC)	FITTINGS ONLY	2"	1/2"	1/2"	LEONARD 76-5A SHOWER SYSTEM W/ PRESSURE BALANCING MIXING VALVE, 1.5 GPM METAL HANDSET, MOUNTING BAR, & FLEXIBLE METAL HOSE. PROVIDE FOLD-UP SEAT, STAINLESS STEEL HORIZONTAL GRAB BAR, SHOWER CURTAIN & ROD, & VINYL FLEXIBLE DAM. DRAIN ASSEMBLY SHALL BE COMPATIBLE W/ SHOWER BASE, WHICH INCLUDES STAINLESS STEEL STRAINER, CLAMPING COLLAR, & SEEPAGE SLOTS.
P-6	WASHING MACHINE	GUY GRAY B200	2"	3/4'	3/4'	GALVANIZED STEEL WASHING MACHINE SUPPLY WITH TWO 3/4" HOSE BIBBS AND WATER HAMMER ARRESTORS. PROVIDE CONNECTIONS TO EQUIPMENT.
P-7	JANITOR'S SERVICE SINK	STERN WILLIAMS HL-1800	3"	1/2"	1/2"	24"x24"x10" DEEP TERRAZZO SERVICE SINK WITH STAINLESS STEEL INTEGRAL CAST CAP, GRID STRAINER, SPLASH GUARDS, AND T&S B-0665-BSTR FAUCET WITH VACUUM BREAKER.
P-8	REFRIGERATOR / ICE MACHINE	GUY GRAY	-	1/2"	-	GALVANIZED STEEL SUPPLY BOX WITH ANGLE SHUTOFF VALVE W/ WATER HAMMER ARRESTOR. PROVIDE CONNECTION TO EQUIPMENT. COORDINATE LOCATION OF FLOOR DRAIN & WATER ROUGH-IN WITH EQUIPMENT.
P-9	DRINKING FOUNTAIN (HC)	HALSEY TAYLOR HRFSEBP FR	1-1/2"	1/2"	-	S.S. SELF CONTAINED, CARRIER SUPPORT, BI-LEVEL EXTERIOR DRINKING FOUNTAIN, WALL MOUNT ADULT ADA "SWIRLFLO" MODELS. LOCATE FPWH/VB DOWNSTREAM OF SUPPLY STOP FOR DRAINING.
P-10	DRINKING FOUNTAIN (HC)	HALSEY TAYLOR HRFEBP FR	1-1/2"	1/2"	-	S.S. SELF CONTAINED, CARRIER SUPPORT, EXTERIOR DRINKING FOUNTAIN, WALL MOUNT ADULT ADA "SWIRLFLO" MODELS. LOCATE FPWH/VB DOWNSTREAM OF SUPPLY STOP FOR DRAINING.
P-II	ELECTRIC WATER COOLER (HC)	HALSEY TAYLOR HTHB-HAC8SS-WF	1-1/2"	1/2"	-	SELF CONTAINED, FLOOR MOUNTED CARRIER, BOTTLE FILLER, FILTERED, 8.8 GPH CAPACITY (80°F AMB. AIR), 4.0 FULL LOAD AMPS, 370 RATED WATT USAGE.
P-12	SINGLE BOWL LAUNDRY TUB	MUSTEE -	2"	1/2"	1/2"	24"x24"x13" (FIELD VERIFY) DEEP COMPOSITE LAUNDRY TUB - ADJUSTABLE LEGS W/ DECK MOUNTED FAUCET PROVIDE MOUNTING BRACKET & FILLER PANELS AS REQUIRED FOR A COMPLETE INSTALLATION.

(HC) DENOTES FIXTURE TO BE DESIGNED, MANUFACTURED AND MOUNTED FOR HANDICAPPED ACCESSIBILITY. • PROVIDE MANUFACTURERS AND MODEL NUMBERS LISTED ABOVE OR APPROVED EQUALS IN STRICT ACCORDANCE WITH ARCHITECTURAL INTERIOR & RESTROOM ELEVATIONS FOR • **PROPER MOUNTING/FIXTURE HEIGHTS AS REQUIRED FOR DIFFERENT STUDENT AGE GROUPS**. FIXTURES AND ADDITIONAL COMPONENTS/FITTINGS REQUIRED FOR SPECIFIC HEIGHT INSTALLATION SHALL BE COORDINATED/VERIFIED WITH THE MOST CURRENT ARCHITECTURAL DRAWINGS/CORRESPONDENCE PRIOR TO ORDERING OR ROUGH-IN. DISCREPANCIES BETWEEN THE PLUMBING DRAWINGS AND ARCHITECTURAL DRAWINGS SHALL BE BROUGHT TO THE ATTENTION OF THE ENGINEER IMMEDIATELY AND PRIOR TO ORDERING FIXTURES OR INSTALLING ROUGH-IN PIPING.

	CIRCULATION PUMP SCHEDULE													
PERFORMANCE DATA ELECTRICAL DATA														
MARK	SERVICE	TYPE	CAPACITY - GPM	HEAD - FT H <sub>2</sub> O	MINIMUM EFFICIENCY-%	MAXIMUM SPEED - RPM	APPROXIMATE MOTOR H.P.	VOLTS	PHASE	HERTZ	REMARKS			
CP-I	HOT WATER		3.0	-	-	3250	1/8	115	1	60	234			

## PUMP SCHEDULE NOTES:

BRONZE FITTED

ACCESSORIES IN THE EASY MAINTENANCE ACCESS (MAX. 6'-0").

(1) CARTRIDGE CIRCULATOR, (2) INSTALL PUMP AND (3) PUMP SHALL BE CONNECTED TO (4) TACO MODEL 008 OR APPROVED EQUAL. DDC SYSTEM FOR START/STOP MECHANICAL ROOM FOR OPERATION/OVERRIDE. AQUASTAT TO CONTROL PUMP DURING OCCUPIED SCHEDULE. SEE ELECTRICAL DWGS.

ELI	ECT	RIC '	WAT	ER	HEA	TER SCHEDULE
MARK	GAL.	VOLTS	ELECTRIC PHASE		KW	REMARKS 123
EWH-1	50	480	3	60	24	A.O. SMITH DRE-52-24

## **WATER HEATER SCHEDULE NOTES:**

(1) EWH DESIGN BASED (2) FIELD VERIFY (3) HEATER SHALL BE ON COMMERCIAL AVAILABLE VOLTAGE PRIOR ELECTRIC WATER TO ORDERING. HEATER OR APPROVED EQUAL.

CONNECTED TO DDC SYSTEM FOR START/STOP OPERATION/OVERRIDE. SEE ELECTRICAL DWGS.

**Dewberry** PREBLE-RISH 203 ABERDEEN PKWY, PANAMA CITY, FL 32405 (850) 522-0644





CLIENT:

**GULF COAST STATE** COLLEGE

5230 US-98 PANAMA CITY **FLORIDA 32401** 850.169.1551 gulfcoast.edu

PROJECT:

GCSC SOFTBALL COMPLEX





CHARLES D. BROWN. PE #42140 RELEASE:

CONSTRUCTION DOCUMENTS


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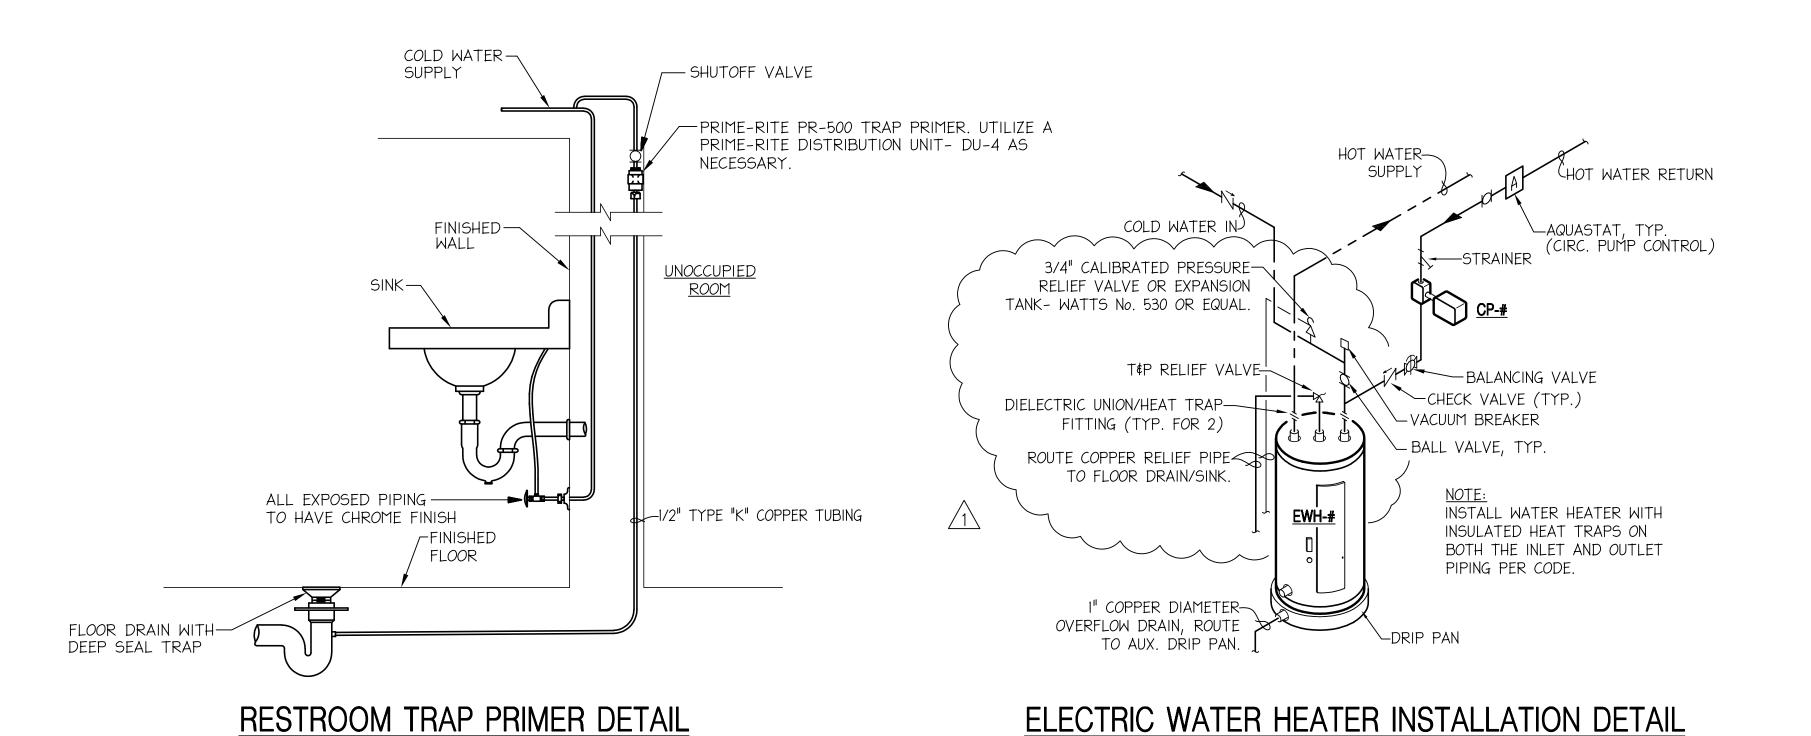
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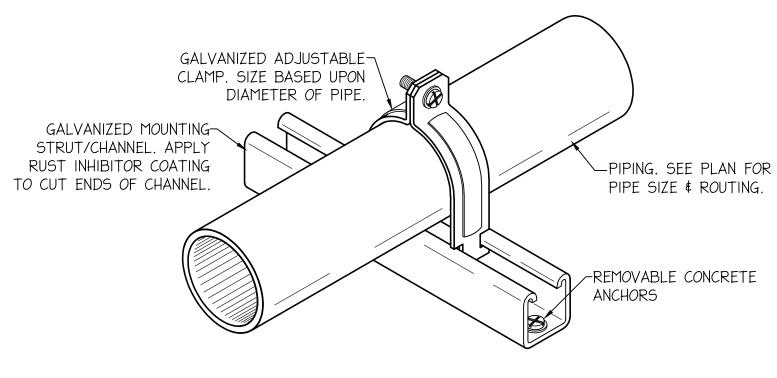
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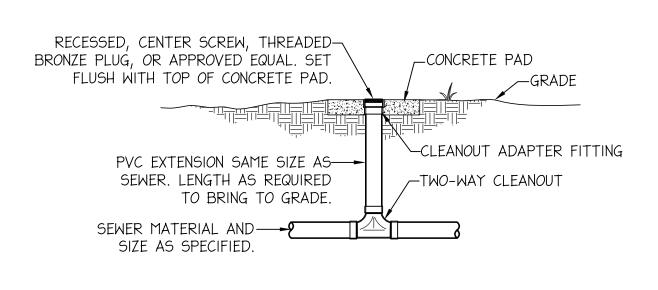
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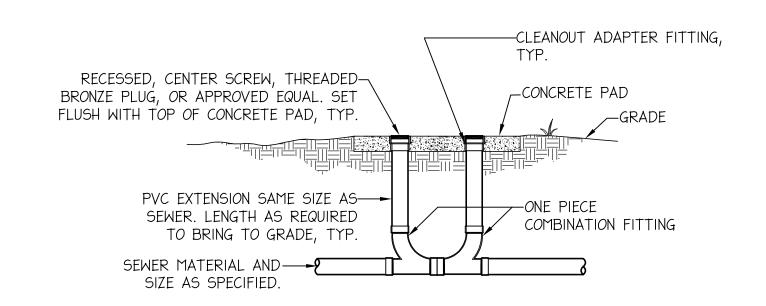


NOT TO SCALE

2-WAY GROUND LEVEL CLEANOUT DETAIL

NOT TO SCALE

(FOR INSTALLATIONS LESS THAN
2'-6" BELOW FINISHED GRADE.)

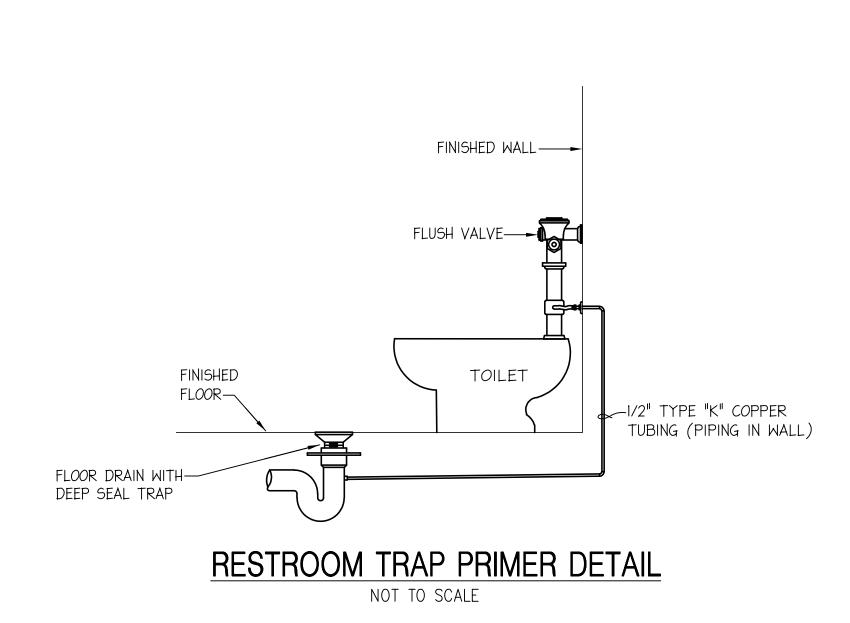

2-WAY GROUND LEVEL CLEANOUT DETAIL

NOT TO SCALE

(FOR INSTALLATIONS GREATER THAN 2'-6" BELOW FINISHED GRADE.)

NOT TO SCALE

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(850) 522-0644





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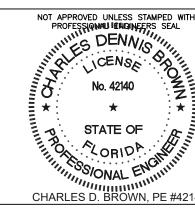
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PROJECT:

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CHARLES D. BROWN, PE #

CONSTRUCTION DOCUMENTS

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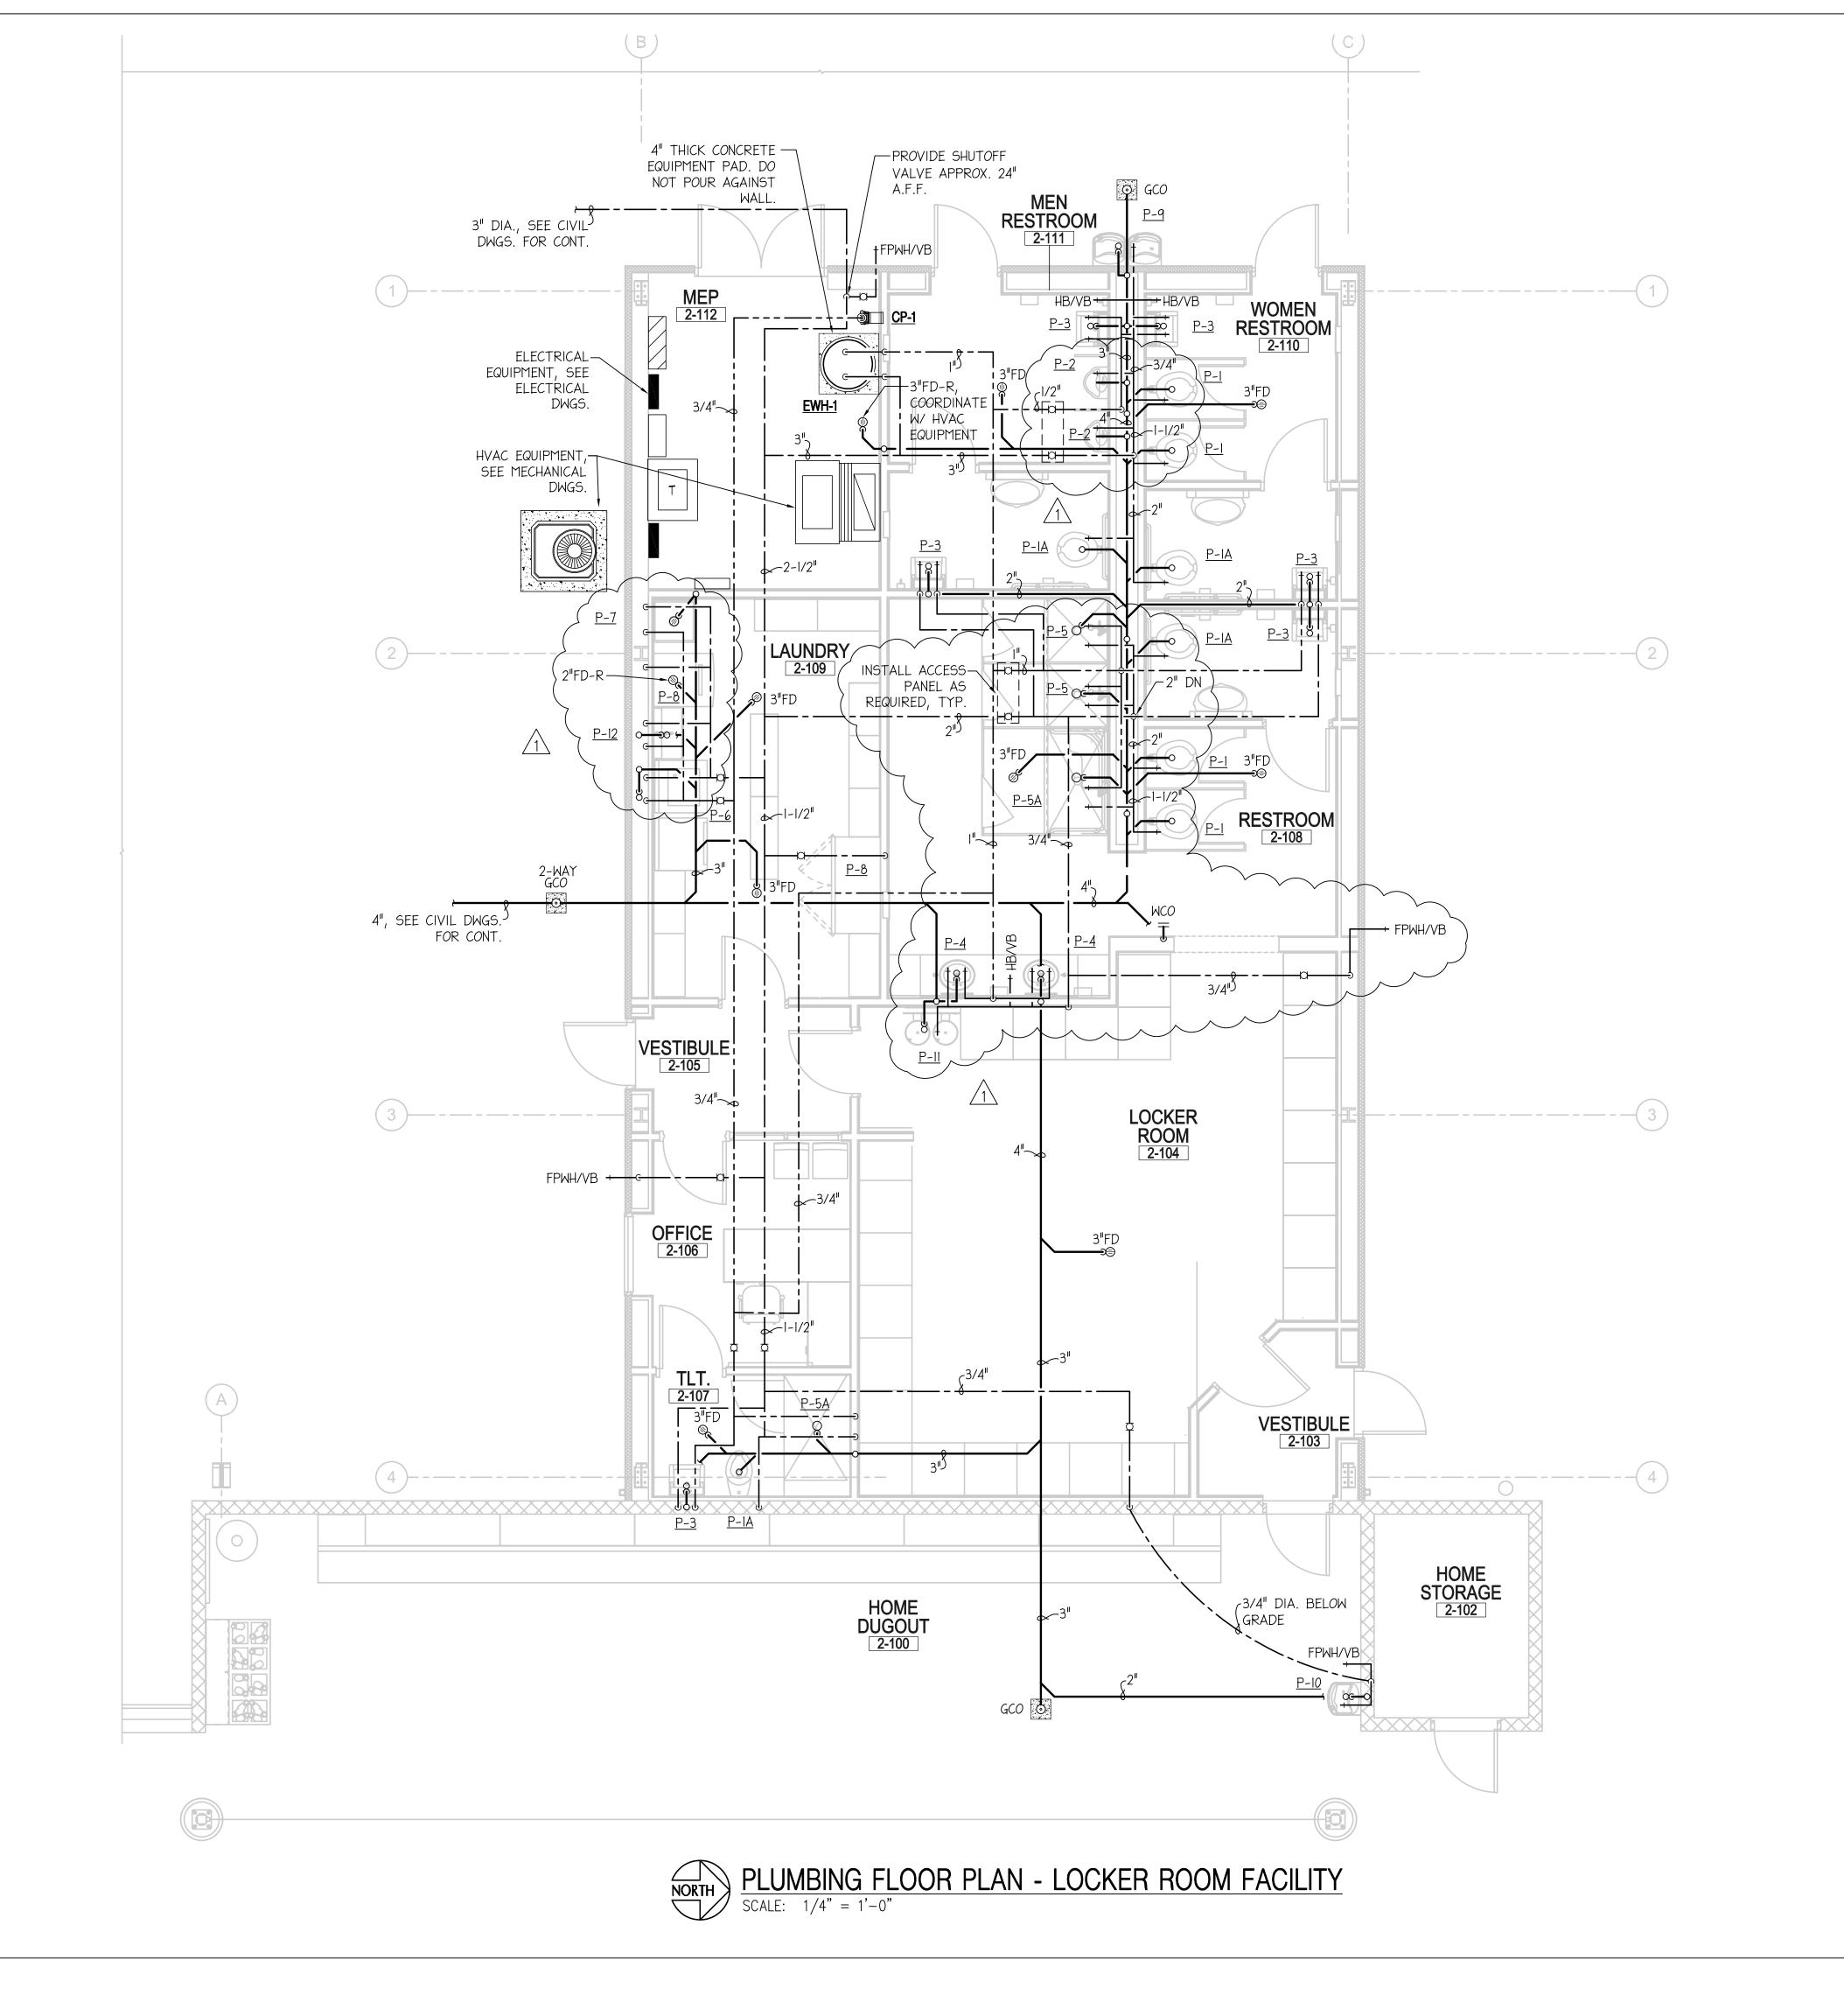
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SHEET TITLE:

PLUMBING DETAILS

PROJECT NO. SHEET **P2** 

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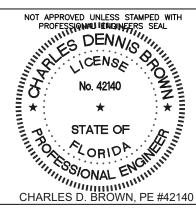
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CHARLES D. BF

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J.W.V		C. D. BROWN	
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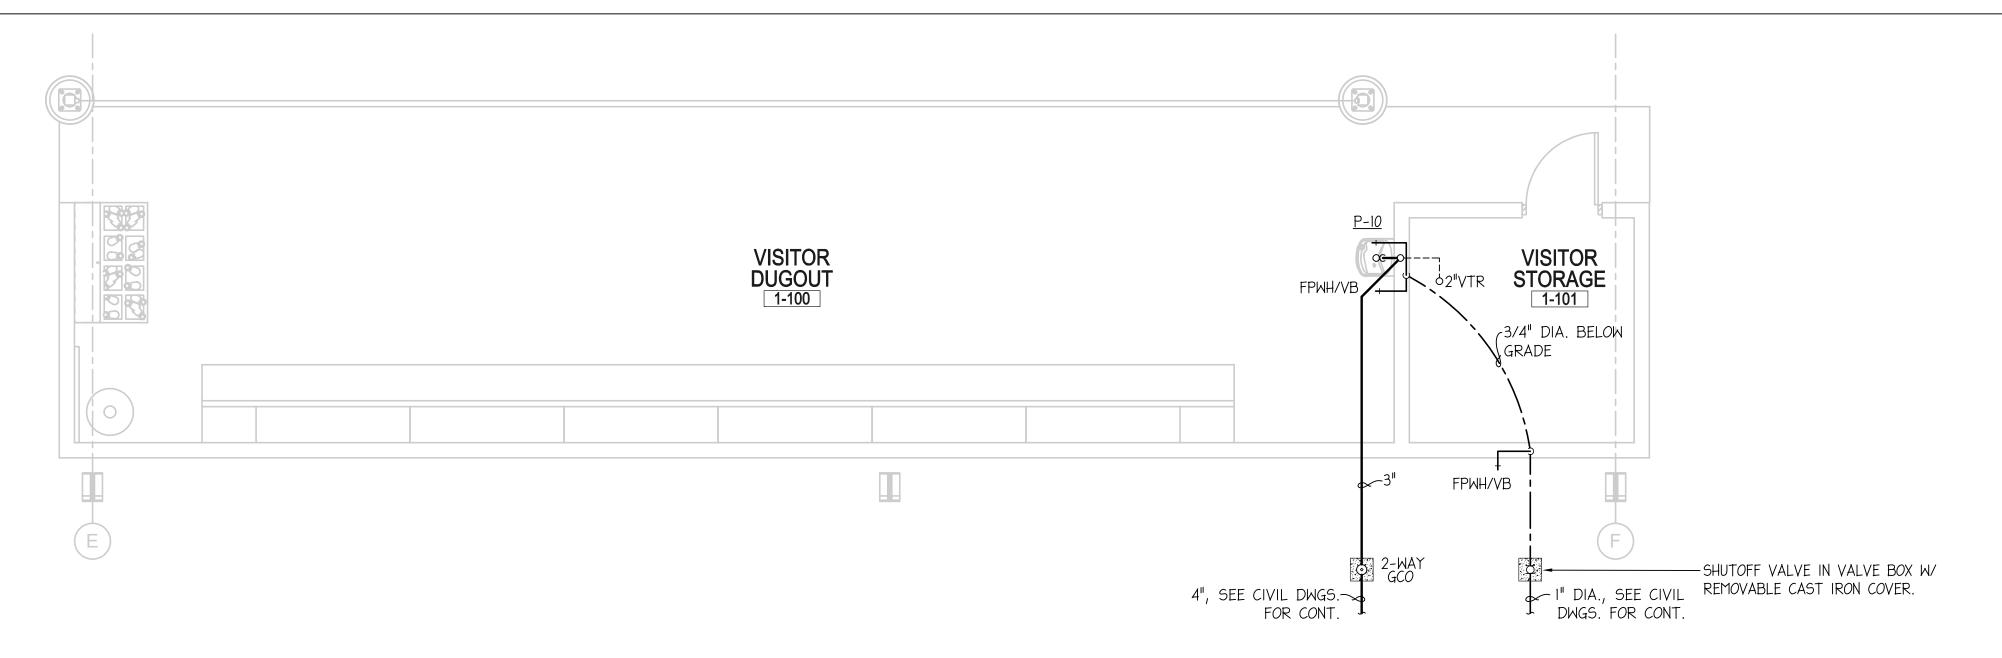
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PLUMBING - LOCKER ROOM FACILITY


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SHEET P4

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# PLUMBING FLOOR PLAN - VISITOR DUGOUT SCALE: 1/4" = 1'-0"



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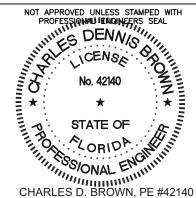
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PROJECT:

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RELEASE:
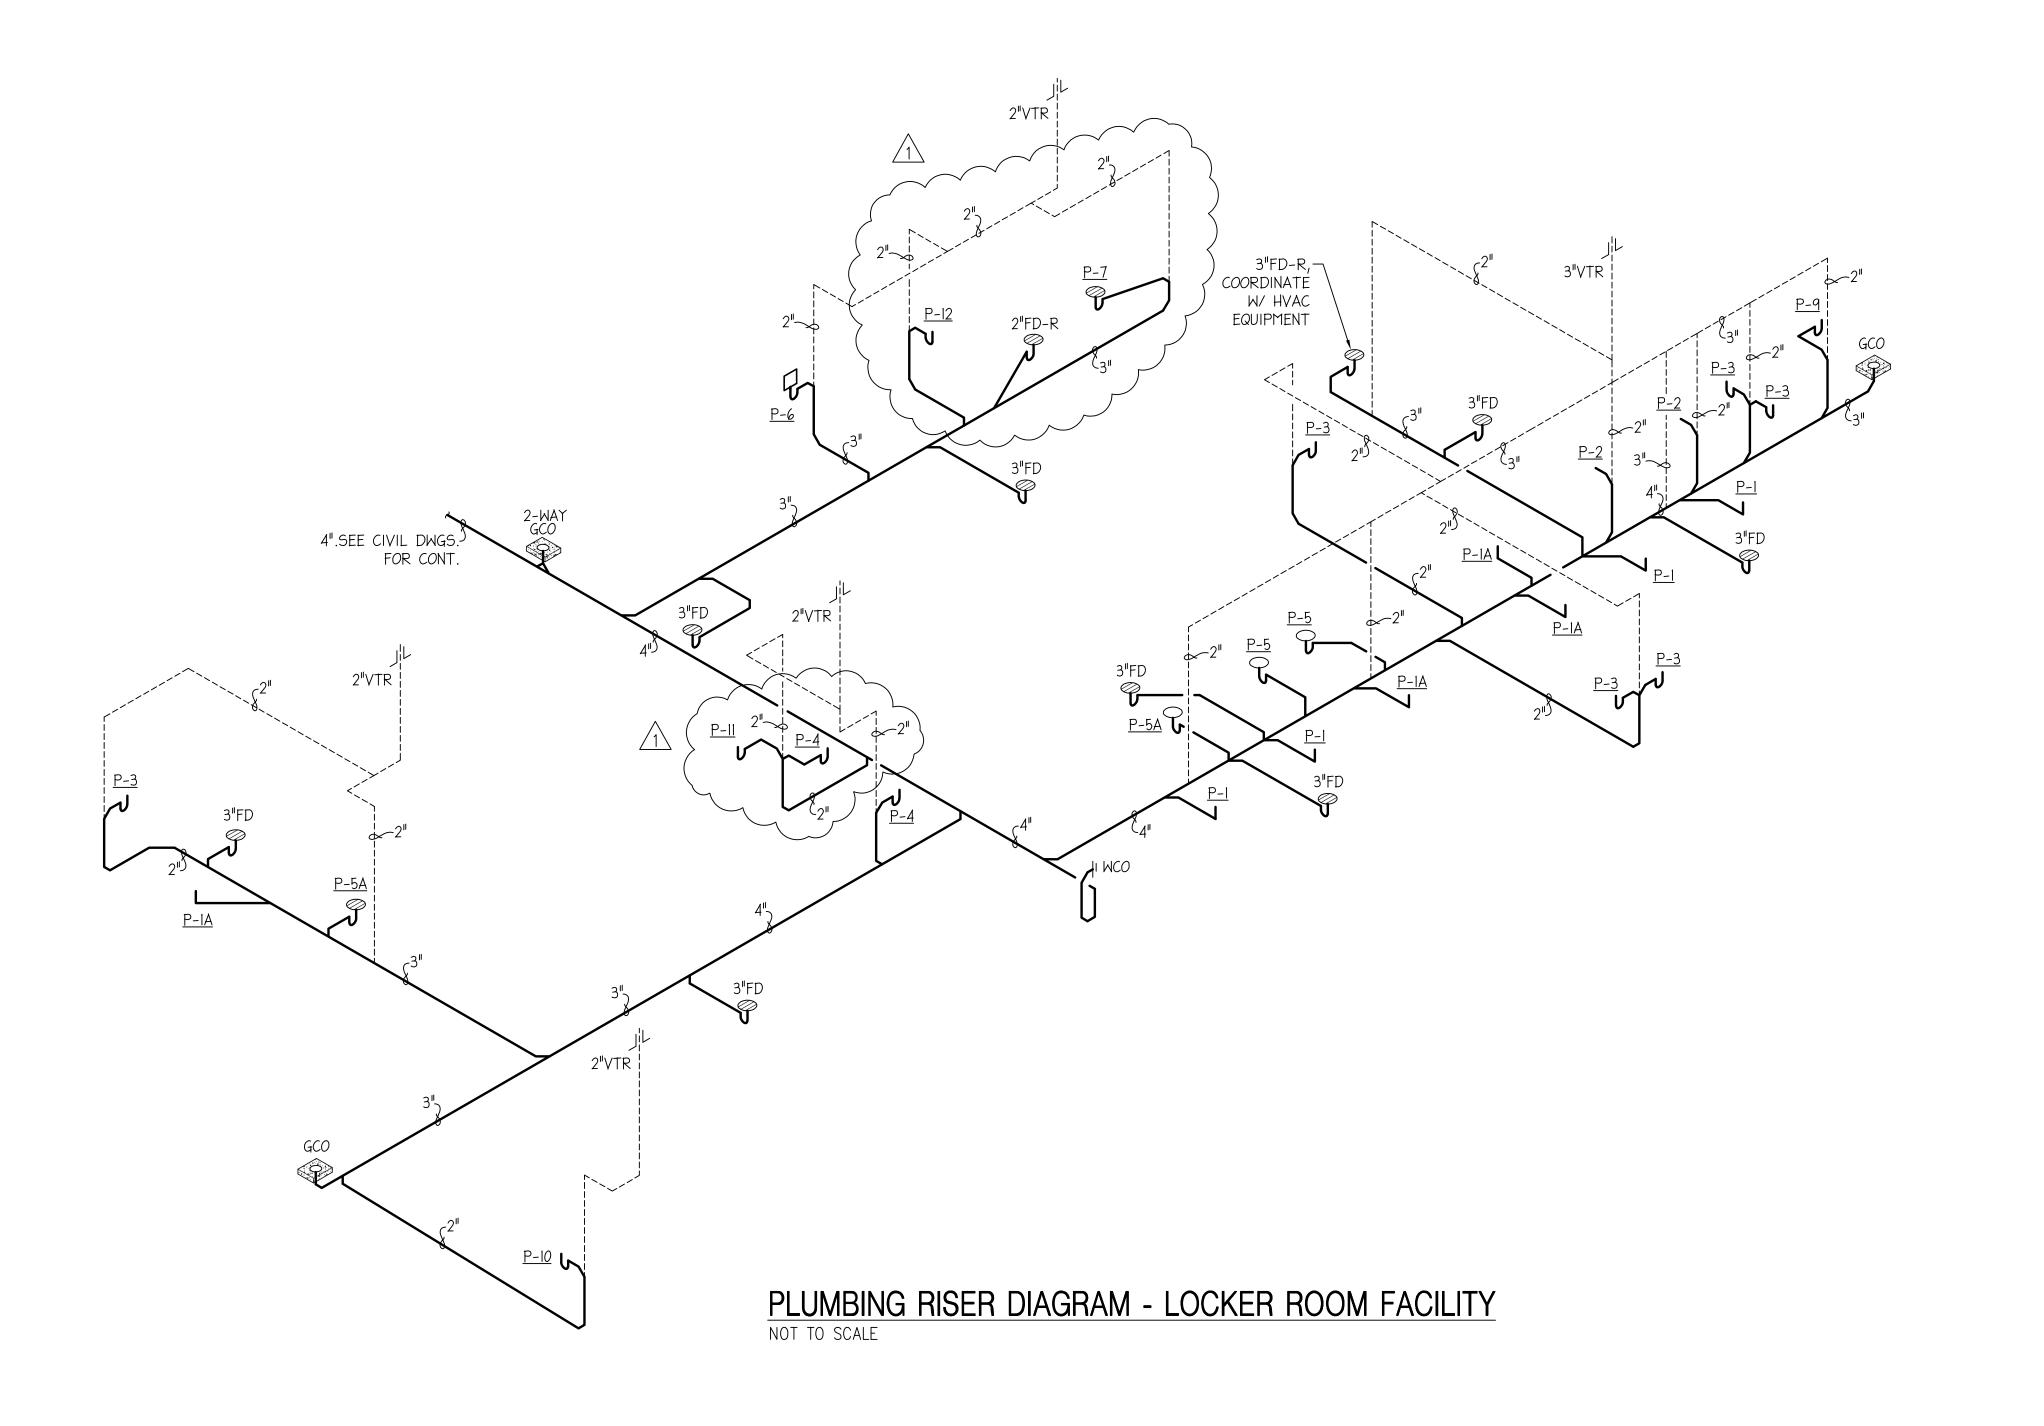
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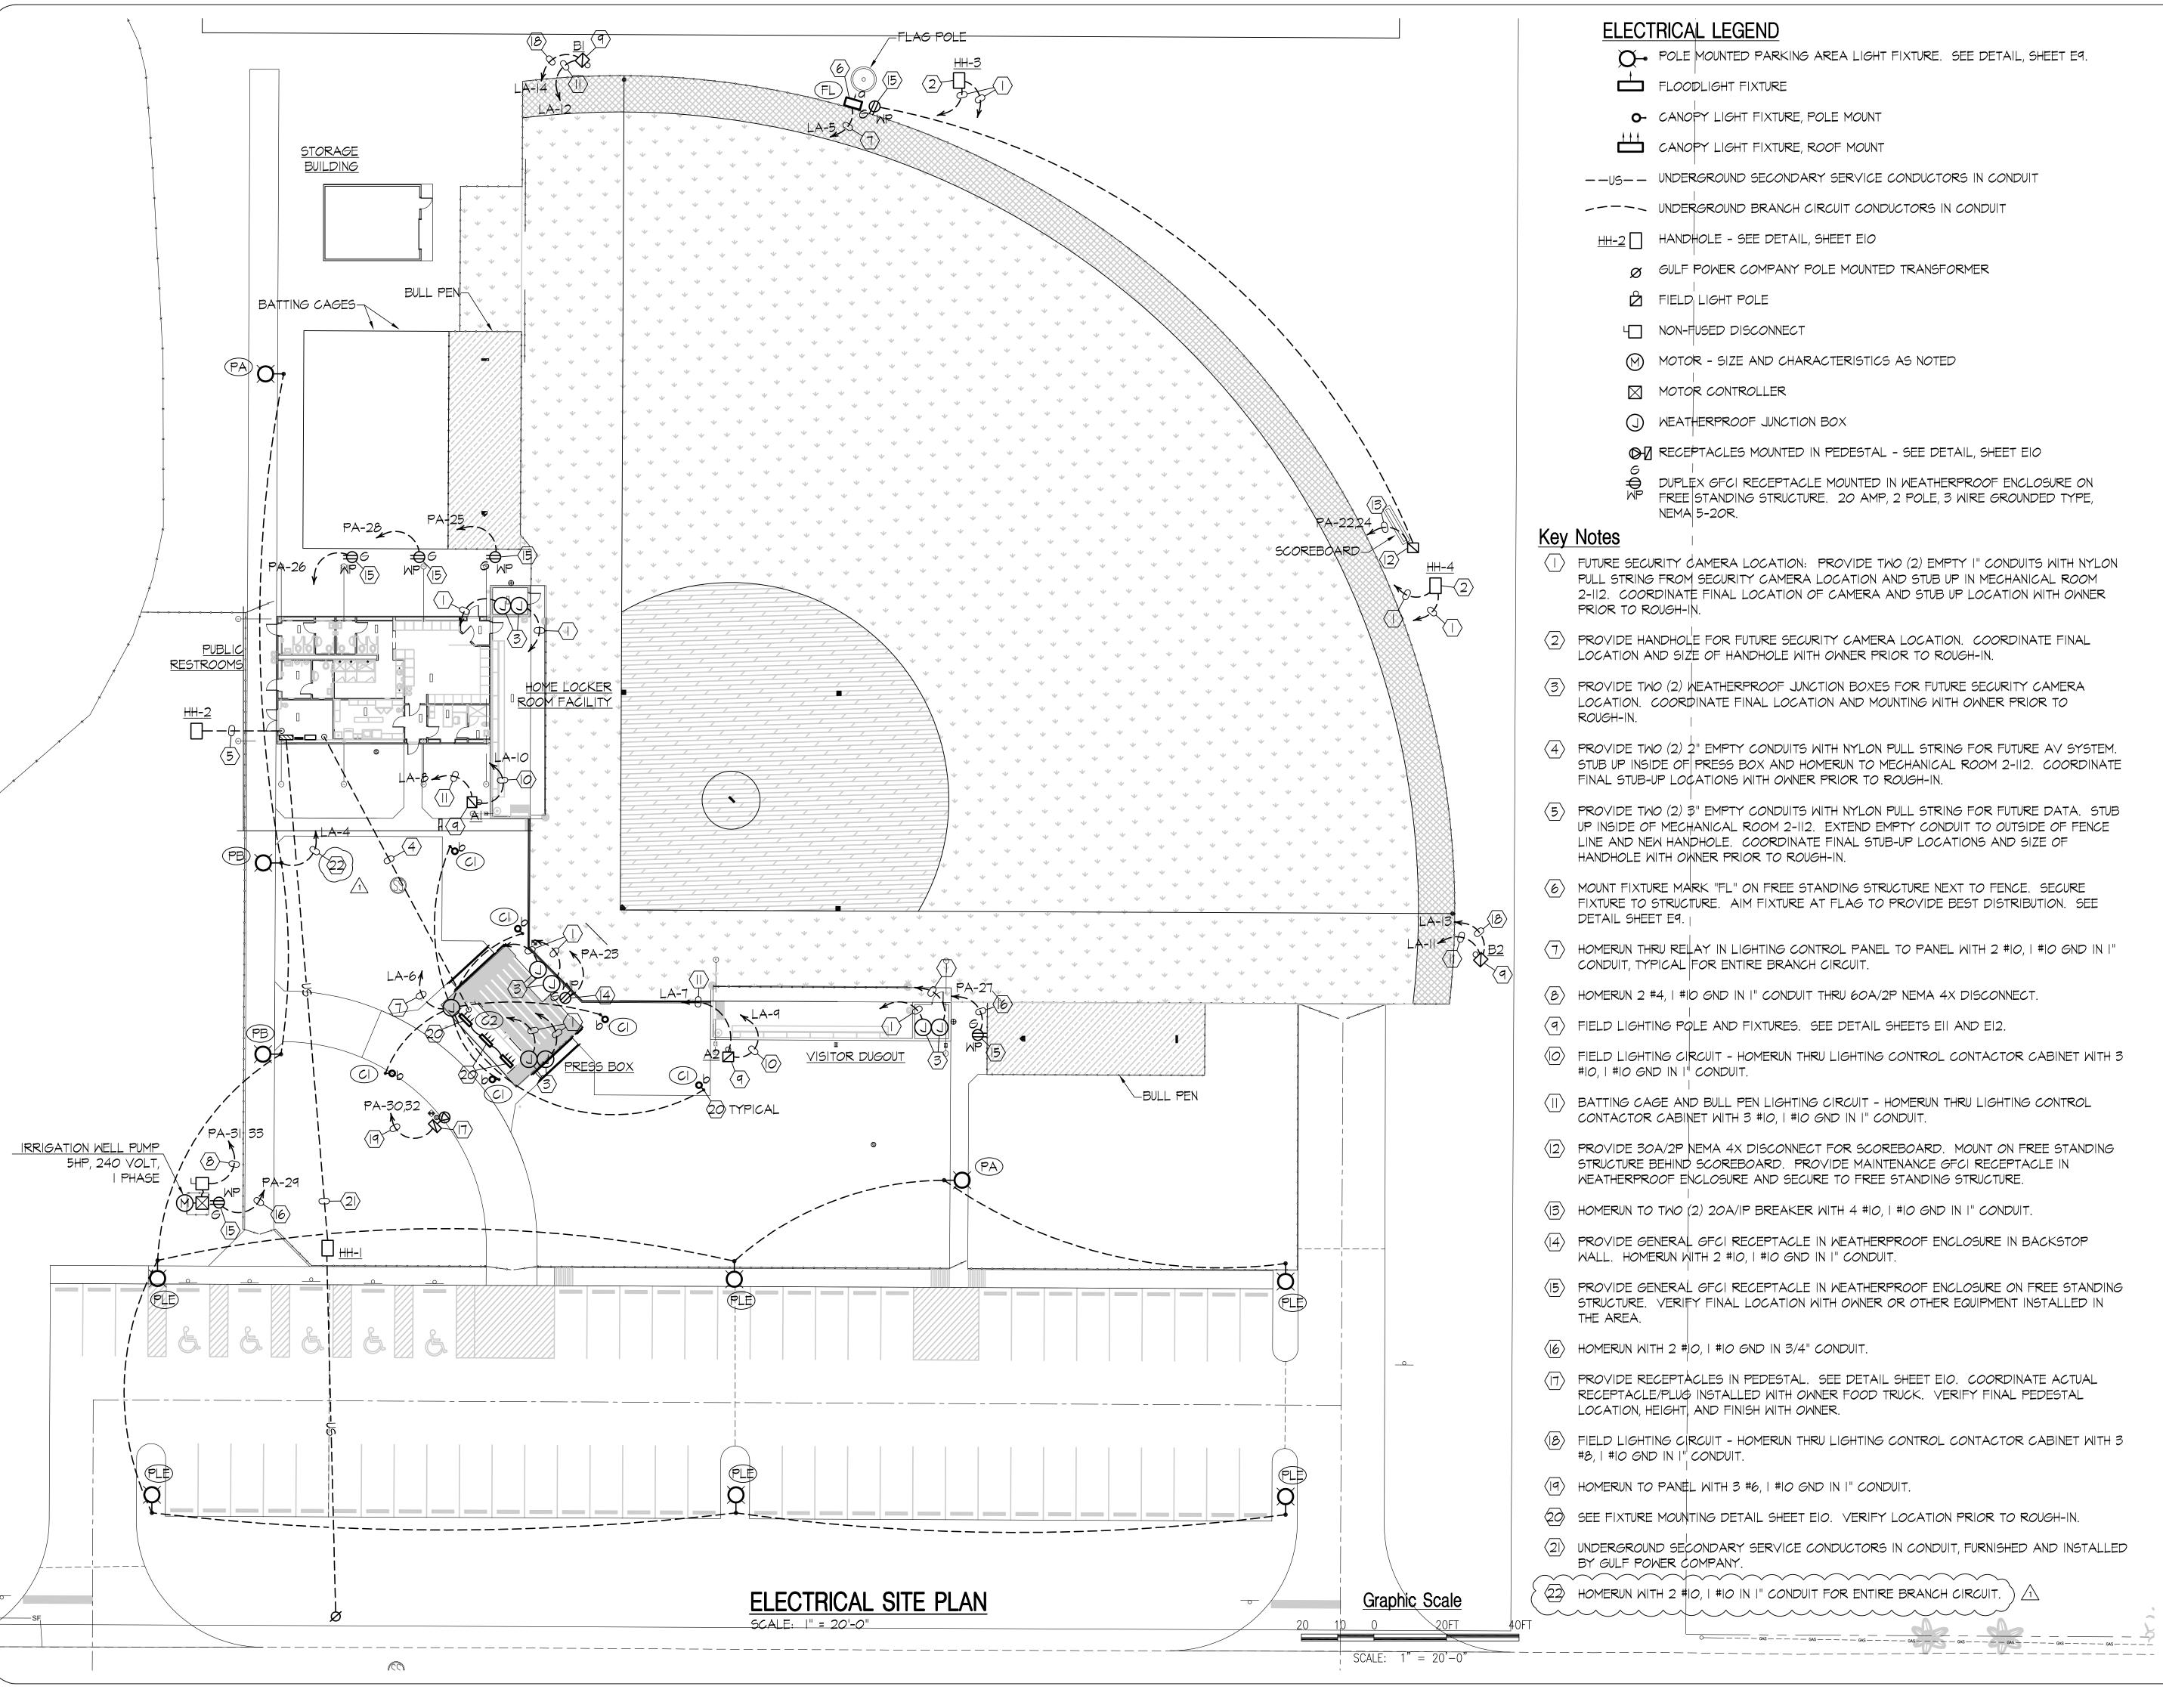
SHEET TITLE:

PLUMBING - VISITOR DUGOUT & RISERS P5

PROJECT NO.

4226

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> > PROJECT:

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CONSTRUCTION DOCUMENTS

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NO.	REVISION:	•	DATE:
1	ADDENDUM No. 1		6-1-17

SHEET TITLE:

ELECTRICAL SITE PLAN

PROJECT NO.

## **ELECTRICAL LEGEND**

#### Ceiling Outlets

- A 2 RECESSED 2' X 4' LED FIXTURE MARK "A" CIRCUIT No. 2 TYPICAL
  - SURFACE MOUNTED OR SUSPENDED FLUORESCENT FIXTURE
  - RECESSED DOWNLIGHT, SUSPENDED OR SURFACE MOUNTED LED FIXTURE
  - JUNCTION BOX
  - <u> Mall Outlets</u>
  - JUNCTION BOX WITH BLANK SCREW COVER AND FLEXIBLE CONDUIT CONNECTION
  - WALL MOUNTED EXIT LIGHT
  - WALL MOUNTED LED LIGHT FIXTURE
  - WALL MOUNTED LINEAR LED LIGHT FIXTURE
  - EMERGENCY LIGHT FIXTURE WITH BATTERY BACKUP
  - SINGLE RECEPTACLE 20 AMP, 125 VOLT, 2 POLE, 3 WIRE GROUNDED TYPE, NEMA 5-20R. MOUNT 18" A.F.F. UNLESS INDICATED OTHERWISE.
  - DUPLEX RECEPTACLE 20 AMP, 125 VOLT, 2 POLE, 3 WIRE GROUNDED TYPE NEMA 5-20R. MOUNT 18" A.F.F. UNLESS INDICATED OTHERWISE.
  - DUPLEX RECEPTACLE 20 AMP, 125 VOLT, 2 POLE, 3 WIRE GROUNDED TYPE NEMA 5-20R. MOUNT ABOVE COUNTER OR 36" A.F.F. UNLESS INDICATED OTHERWISE

DOUBLE DUPLEX RECEPTACLE - 20 AMP, 125 VOLT, 2 POLE, 3 WIRE GROUNDED


- DUPLEX RECEPTACLE 20 AMP, 125 VOLT, 2 POLE, 3 WIRE GROUNDED TYPE
- NEMA 5-20R. MOUNT UP IN TRUSS SYSTEM FOR A/V.
- TYPE, NEMA 5-20R. MOUNT 18" A.F.F. UNLESS INDICATED OTHERWISE. SINGLE RECEPTACLE - 30 AMP, 125/250 VOLT, 3 POLE, 4 WIRE GROUNDED TYPE, NEMA 14-30R WITH MATCHING PLUG. MOUNT 18" A.F.F.
- Mall Switches (Mount 48" A.F.F. unless otherwise noted)
- S A.C. TYPE, SINGLE POLE, 20 AMP, 120/277 VOLT
- S3 A.C. TYPE, 3-WAY, 20 AMP, 120/277 VOLT
- Sa WALL SWITCH CONTROLS OUTLET "a". ETC.
- LINE VOLTAGE DIGITAL SWITCH WITH INTEGRAL TIMER FOR AUTOMATIC SHUTOFF WATTSTOPPER No. TS-400
- SDI LINE VOLTAGE SWITCH WITH INTEGRAL OCCUPANCY SENSOR. WATTSTOPPER No. DW-100
- SD DIGITAL NETWORK SWITCH WITH NUMBER OF PRESET BUTTONS AS INDICATED FOR LIGHTING CONTROL. VERIFY BUTTON QUANTITY AND FUNCTION WITH OWNER. <u>Branch Circuitina</u>
- ----- RUN EXPOSED PERPENDICULAR AND PARALLEL TO BUILDING LINES
- / RUN CONCEALED UNDER FLOOR
- RUN CONCEALED IN CEILING OR WALLS
  - HOMERUN TO PANEL. ANY CIRCUIT WITHOUT FURTHER IDENTIFICATION INDICATES 2 #12, | #12 GROUND 1/2" C; 4 #10, 1 #12 GROUND - 1/2" C; ETC. AS PER NEC. LETTERS AND NUMERALS INDICATE PANEL AND CIRCUIT NUMBER.
- FLEXIBLE CONDUIT CONNECTION
- ---- EMPTY CONDUIT WITH PULL CORD
  - LOW VOLTAGE WIRING IN 1/2" CONDUIT CONCEALED ABOVE CEILING
  - Panels and Power
- POWER PANELBOARD
- LIGHTING PANELBOARD
- TOGGLE TYPE MANUAL MOTOR CONTROLLER
- EXHAUST FAN
- NON-FUSIBLE DISCONNECT SWITCH
- MOTOR SIZE AND CHARACTERISTICS AS NOTED
- MOTOR CONTROLLER
- VARIABLE FREQUENCY DRIVE PROVIDED BY OTHERS INSTALLED BY ELECTRICAL CONTRACTOR
- WATTHOUR DEMAND METER
- DRY TYPE PAD MOUNTED TRANSFORMER
- SURGE PROTECTIVE DEVICE

#### <u>Miscellaneous</u>


- A.F.F. ABOVE FINISH FLOOR
- WEATHERPROOF
- EWC ELECTRIC WATER COOLER
- TV TV RECEPTACLE SEE TELCOM DRAWING FOR EXACT MOUNTING HEIGHT AND LOCATION
- INDICATES FIXTURE MARK IN AREA SHOWN

GROUND FAULT CIRCUIT INTERRUPTER

- PROVIDE WITH ACRYLIC POLYCARBONATE GUARD
- PROVIDE WITH WIRE GUARD
- DUAL TECHNOLOGY CEILING MOUNTED OCCUPANCY SENSOR WATTSTOPPER No. LMDC-100
- LINE VOLTAGE DUAL TECHNOLOGY CEILING MOUNTED OCCUPANCY SENSOR WATTSTOPPER No. DT-355
- DAYLIGHT SENSOR CEILING MOUNTED, LOW VOLTAGE WATTSTOPPER No. LMLS-500
- LIGHTING CONTROL PANEL SEE LIGHTING CONTROL PANEL DETAIL "C", SHEET E3
- WIRELESS PARKING LOT LIGHTING CONTROL SYSTEM WATTSTOPPER No. 225CMS
- LIGHTING CONTROL ROOM MODULE SEE LIGHTING CONTROL MODULE WIRING DIAGRAMS THIS SHEET

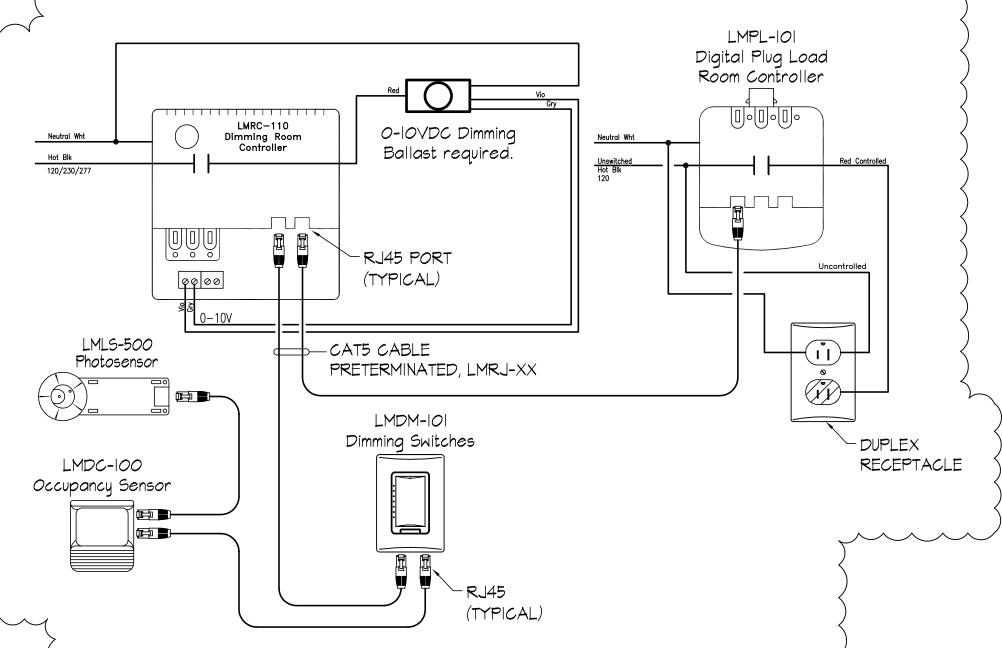

## TYPICAL LIGHTING CONTROL WIRING DIAGRAM "A" NOT TO SCALE

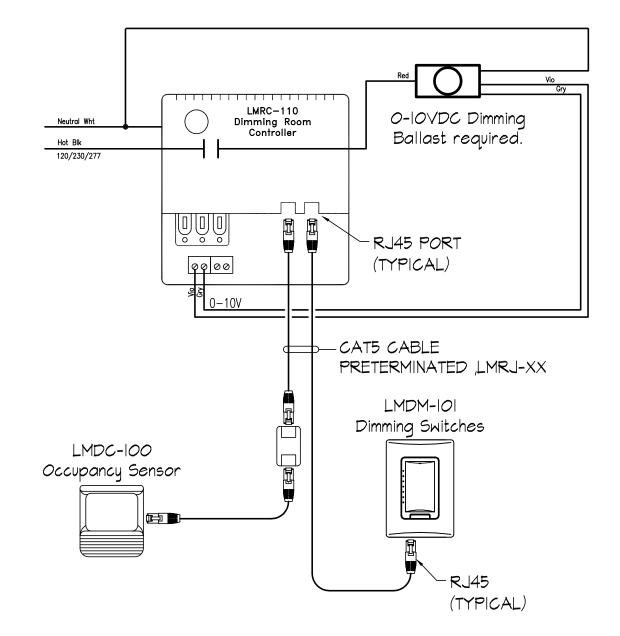

TYPICAL LIGHTING CONTROL WIRING DIAGRAM "B" NOT TO SCALE (LOCKER ROOM)

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## GENERAL NOTES

I. THE ELECTRICAL WORK TO BE PROVIDED SHALL COVER THE FURNISHING OF EQUIPMENT AND MATERIALS, THE PERFORMANCE OF ALL LABOR WITH SUPERVISION, THE BEARING OF ALL EXPENSE, ALL AS NECESSARY FOR THE SATISFACTORY COMPLETION OF ALL WORK READY FOR OPERATION AS SHOWN ON THE DRAWINGS

- 2. THE INSTALLATION SHALL COMPLY WITH ALL STATE, LOCAL CODES, LAWS AND ORDINANCES APPLICABLE TO ELECTRICAL WORK, N.F.P.A. LIFE SAFETY CODE, STANDARD BUILDING CODE AND THE NATIONAL ELECTRICAL CODE.
- 3. PANELBOARDS SHALL BE CIRCUIT BREAKER TYPE WITH KEYED LOCK ON DOOR. PROVIDE EACH NEW AND EXISTING PANEL WITH TYPE WRITTEN DIRECTORY TO INDICATE LOAD SERVED BY EACH BREAKER. CIRCUIT BREAKERS SHALL BE UL 489 THERMAL MAGNETIC-TYPE WITH SHORT CIRCUIT INTERRUPTING CAPACITIES INDICATED IN PANEL SCHEDULE
- 4. ALL INSIDE WORK SHALL BE INSTALLED IN CONDUIT CONCEALED TYPE CONSTRUCTION. CONDUITS SHALL NOT BE RUN EXPOSED ON CONCRETE BLOCK WALLS ON FINISHED SPACES.
- 5. GALVANIZED RIGID STEEL OR IMC SHALL BE INSTALLED IN WET OR DAMP LOCATIONS AND EXPOSED OUTSIDE. MINIMUM 1/2" DIAMETER.
- 6. THINWALL (EMT) CONDUIT MAY BE USED INSIDE. MINIMUM 3/4" DIAMETER.
  - a. COUPLINGS AND CONNECTORS FOR USE WITH EMT SHALL BE ALL STEEL COMPRESSION TYPE.
  - b. CONDUIT FITTINGS SHALL BE ZINC COATED
  - c. CONDUIT SHALL BE SECURELY FASTENED TO ALL OUTLET BOXES OR CABINETS WITH LOCKNUTS AND BUSHINGS OF APPROVED MAKE.
  - d. ALL JUNCTION BOXES SHALL HAVE CIRCUIT NUMBER IDENTIFIED ON COVER AND COLOR-CODED AS FOLLOWS:

ORANGE - 480Y/277 VOLT BLUE - 208Y/120 YOLT RED - FIRE ALARM

- 7. CONDUCTORS SHALL BE MINIMUM #12 AWG SOLID COPPER WITH TYPE THW, THHN OR THWN 600 VOLT INSULATION.
- 8. OUTLET BOXES SHALL BE 4" SQUARE, GALVANIZED, NOT LESS THAN 1-5/8" DEEP
- 9. RECEPTACLES: RECEPTACLES SHALL BE FURNISHED AND INSTALLED WHERE SHOWN ON THE DRAWINGS AND SHALL BE HEAVY DUTY SPECIFICATION GRADE AND SHALL BE RATED 20 AMP, 125 VOLT, 2 POLE, 3 WIRE, HUBBELL "CR" SERIES OR APPROVED EQUAL
- 10. WALL PLATES: ALL SWITCH, RECEPTACLE, AND EMPTY CONDUIT SYSTEM OUTLET PLATES, UNLESS OTHERWISE NOTED, SHALL BE STAINLESS STEEL
- II. ALL LIGHTING FIXTURES SHALL BE COMPLETE WITH AUXILIARIES, ACCESSORIES, HANGERS, SUPPORTS,
- 12. SAFETY SWITCHES SHALL BE HEAVY DUTY TYPE 600 VOLT WITH NUMBER OF POLES AND AMPERE RATING AS INDICATED.
- 13. ALL MATERIALS AND EQUIPMENT SHALL BE NEW, OF QUALITY SPECIFIED, AND AS LISTED IN PRINTED CATALOGS OF THE MANUFACTURER. UNLESS OTHERWISE SPECIFIED, ALL ITEMS SHALL HAVE THE MANUFACTURER'S STANDARD FINISH.
- 14. THE CONTRACTOR SHALL AFFIRM WITH GULF POWER COMPANY THAT THE LOCATION. ARRANGEMENT AND CONNECTION TO THE ELECTRICAL UTILITY SERVICE, AS WELL AS REQUIRED METERING EQUIPMENT, IS IN ACCORDANCE WITH THE REQUIREMENTS OF THE GULF POWER COMPANY.
- 15. THE CONTRACTOR SHALL COORDINATE SIZES INDICATED FOR ELECTRICAL COMPONENTS SUCH AS CIRCUIT BREAKERS, DISCONNECTS, AND FEEDERS WITH THE REQUIREMENTS FOR EQUIPMENT ACTUALLY PROVIDED.
- 16. IN ACCORDANCE WITH NFPA 70, GROUND EXPOSED NON-CURRENT-CARRYING METALLIC PARTS OF ELECTRICAL EQUIPMENT, METALLIC RACEWAYS, GROUNDING CONDUCTOR IN METALLIC RACEWAYS, AND NEUTRAL CONDUCTOR OF WIRING SYSTEMS. MAXIMUM RESISTANCE-TO-GROUND OF GROUNDING SYSTEM SHALL NOT EXCEED 25-ohms UNDER DRY CONDITIONS.

## **Dewberry** PREBLE-RISH

203 ABERDEEN PKWY, PANAMA CITY, FL 32405 (850) 522-0644

> CONSULTANTS LICENSE #AAOOO2730



**CLIENT:** 

**GULF COAST STATE** COLLEGE

5230 US-98 PANAMA CITY **FLORIDA 32401** 850.169.1551 gulfcoast.edu

PROJECT:

GCSC SOFTBALL COMPLEX





RELEASE:

SCALE:

CONSTRUCTION DOCUMENTS

DATE:


As indicated		05/04/2017	
DRA T. A.	WN: BOLTON	CHECKED: M. J. REID	
NO.	REVISION:		DATE:
1	ADDENDUM No. 1		6-1-17

SHEET TITLE: ELECTRICAL


**LEGEND** PROJECT NO. SHEET

E2


LIGHTING FIXTURE					
MARK	MANUFACTURER & CATALOG No.	No.	LAMPS TYPE	MOUNTING	DESCRIPTION
D	LITHONIA No. LDN6 35/10 L06 WR LSS MVOLT WL	-	10.2W LED 3500K	RECESSED	NOMINAL 6" RECESSED LED DOWNLIGHT WITH 1000 LUMEN OUTPUT AT 3500K, COMFORT CLEAR REFLECTOR WITH WHITE FLANGE, UNIVERSAL VOLTAGE DRIVER, WET LOCATION LISTED.
E	PHILIPS No. CXXL3RW	-	LED	UNIVERSAL	NOMINAL LED EXIT LIGHT FIXTURE WITH UNIVERSAL MOUNTING, UNIVERSAL FACES, WHITE THERMOPLASTIC HOUSING WITH EMERGENCY BATTERY BACKUP WITH SELF TEST FEATURE.
EM	LITHONIA No. ELM2LEDSD	-	LED	WALL MOUNT 8'-0" A.F.F.	NOMINAL LED EMERGENCY FIXTURE, DAMP LOCATION LISTED WITH EMERGENCY BATTERY BACKUP AND SELF TEST FEATURE. MEETS EGRESS 6' PATH REQUIREMENTS WITH 20' SPACING.
Gl	LITHONIA No. TL4 20L FW AI9 LP835 (DGAI4)	-	15.3W LED 3500K	RECESSED	NOMINAL IX4 RECESSED LENSED LED TROFFER WITH 0.156" THICK ACRYLIC LENS, STANDARD DRIVER, 2000 LUMEN OUTPUT. PROVIDE WITH HARD CEILING ADAPTER KIT WHERE NECESSARY.
<i>6</i> 2	LITHONIA No. TL4 30L FW AI9 LP835 (DGAI4)	-	15.3W LED 3500K	RECESSED	SIMILAR TO FIXTURE MARK GI EXCEPT 3000 LUMEN OUTPUT.
63	LITHONIA No. 2TL4 3OL FW AI9 LP835 (DGA24)	-	15.3W LED 3500K	RECESSED	NOMINAL 2X4 RECESSED LENSED LED TROFFER WITH 0.156" THICK ACRYLIC LENS, STANDARD DRIVER, 2000 LUMEN OUTPUT. PROVIDE WITH HARD CEILING ADAPTER KIT WHERE NECESSARY.
Y	LITHONIA No. ZL2N L48 3000LM MDD MVOLT 35K 80CRI	-	28W LED 3500K	SURFACE MOUNT	NOMINAL 4' LED SURFACE OR PENDANT MOUNT FIXTURE WITH 3000 LUMEN OUTPUT AT 3500K, UNIVERSAL VOLTAGE DRIVER, AND WIRE GUARD.
M2	LITHONIA No. ZL2N L48 3000LM MDD MVOLT 35K 80CRI	-	48W LED 3500K	SURFACE MOUNT	SIMILAR TO FIXTURE MARK "MI" EXCEPT 4800 LUMEN OUTPUT.
Ω.	LITHONIA No. 2ALL4 48L EZI LP835 (DGA24)	-	30W LED 3500K	RECESSED	ARCHITECTURAL 2' X 4' LED VOLUMETRIC TROFFER WITH HINGED DOOR FRAME, FROSTED ACRYLIC LENS, 4800 LUMEN OUTPUT AT 3500K, UNIVERSAL VOLTAGE DRIVER.
SI	LITHONIA No. TLX4 30L FW AI9 LP835	-	30W LED 3500K	RECESSED	NOMINAL IX4 SURFACE MOUNT LENSED LED TROFFER WITH O.156" THICK ACRYLIC LENS, STANDARD DRIVER, 2000 LUMEN OUTPUT.
SMI	KENALL No. MLHA8 24F XX PP 25L35 DDC DV DL	-	40W LED 3500K	SURFACE MOUNT	VANDAL RESISTANT IX2 LED SURFACE MOUNTED FIXTURE WITH OPAL ACRYLIC LENS, 2500 LUMEN OUTPUT AT 3500K, UNIVERSAL VOLTAGE DRIVER. VERIFY FINISH WITH OWNER.
WBI	KENALL No. MLHA8 24F XX PP 25L35 DDC DV DL	-	54W LED 3500K	WALL MOUNT 8'-0" A.F.F. OR ABOVE MIRROR	SIMILAR TO FIXTURE MARK SMI EXCEPT WALL MOUNT
WPI	LITHONIA No. DSWXI LED IOC 530 40K T3M MVOLT	-	36W LED 4000K	WALL MOUNT 10'-0" A.F.F.	LED WALL MOUNT LED LOT FIXTURE TYPE 3 DISTRIBUTION, 3000LUMEN OUTPUT AT 4000K, UNIVERSAL VOLTAGE DRIVER, VERIFY FINISH WITH OWNER/ARCHITECT.
MP2	LITHONIA No. DSWXI LED IOC 530 40K T3M MVOLT-PE	-	36W LED 4000K	WALL MOUNT 10'-0" A.F.F.	SIMILAR TO FIXTURE MARK WPI EXCEPT WITH INTEGRAL PHOTOCELL.
*PLE	LITHONIA No. DSX2 LED 100C 700 40K MVOLT RPA PERT SF (FINISH) POLE: RTA 30 106 (FINISH)	-	35W LED 4000K	POLE MOUNT 30'-0" A.F.F.	OWNER FURNISHED CONTRACTOR INSTALLED. LED POLE MOUNT LIGHT FIXTURE TYPE 3 DISTRIBUTION AND WATTSTOPPER No. NWTL-III-IP WIRELESS CONTROLS.
PA	LITHONIA No. DSXO LED 20C 530 40K TIS MVOLT RPA PERT SF (FINISH) POLE: RSA-12-4C (FINISH)	-	35W LED 4000K	POLE MOUNT 12'-0" A.F.F.	LED POLE MOUNT PEDESTRIAN LIGHT FIXTURE, TYPE TI DISTRIBUTION, 4380 LUMEN AT 4000K. VERIFY FINISH WITH OWNER. PROVIDE WITH WATTSTOPPER No. NWTL-III-IP CONTROLLER
PB	LITHONIA No. DSXO LED 20C 53O 40K T5M MVOLT RPA PERT SF (FINISH, POLE: RSA-12-4C (FINISH)	-	35W LED 4000K	POLE MOUNT 12'-0" A.F.F.	SIMILAR TO FIXTURE MARK PA EXCEPT TYPE 5 DISTRIBUTION AND 4734 LUMEN OUTPUT.
FL	LITHONIA No. DSXF3 LED 6 P2 40K MFL MVOLT YKC62 FTSCG6 UBV VG	xx -	183W LED 4000K	POLE MOUNT 3'-0" A.F.F.	NOMINAL LED FLOOD LIGHT FIXTURE WITH DIE CAST ALUMINUM HOUSING, VANDAL GUARD, VISOR, IP66 RATED, WITH 17000 LUMEN OUTPUT AT 4000K TEMP. VERIFY SO CORD LENGTH.
O	LUMENPULSE No. LBL 277 40K NF LSL XX NO SY XX PM4-1	-	50W LED 4000K	POLE MOUNT 1'-O" BELOW SHADE ATTACH.	NOMINAL LED FLOOD LIGHT FIXTURE WITH DIE CAST ALUMINUM HOUSING, CLEAR TEMPERED GLASS, IP66 RATED WITH 2600 LUMEN OUTPUT AT 4000K TEMP. VERIFY SO CORD LENGTH.
C2	ECOSENSE No. L50-1-48-12-40-80-MULT-25X45	-	48W LED 4000K	ROOF MOUNT ON PRESS BOX SEE DETAIL	NOMINAL LINEAR LED FLOOD LIGHT FIXTURE WITH EXTRUDED ALUMINUM HOUSING, INTEGRAL CONNECTORS, IP66 RATED WITH 3700 LUMEN OUTPUT AT 4000K TEMP. VERIFY CABLES LENGTHS.

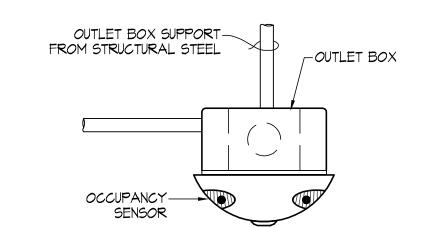

# CEILING MOUNT OCCUPANCY SENSOR MOUNTING DETAIL

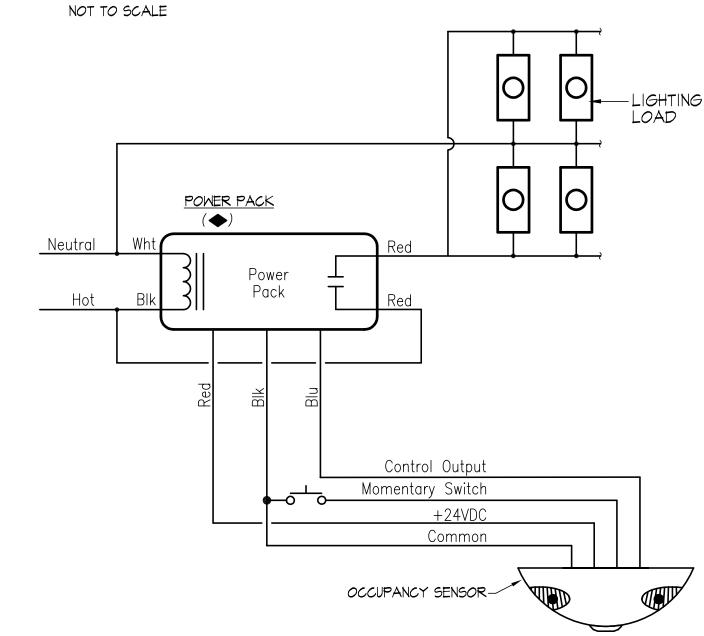

# TYPICAL LINE VOLTAGE LIGHTING CONTROL DIAGRAM OCCUPANCY SENSOR NO LOCAL SWITCHING

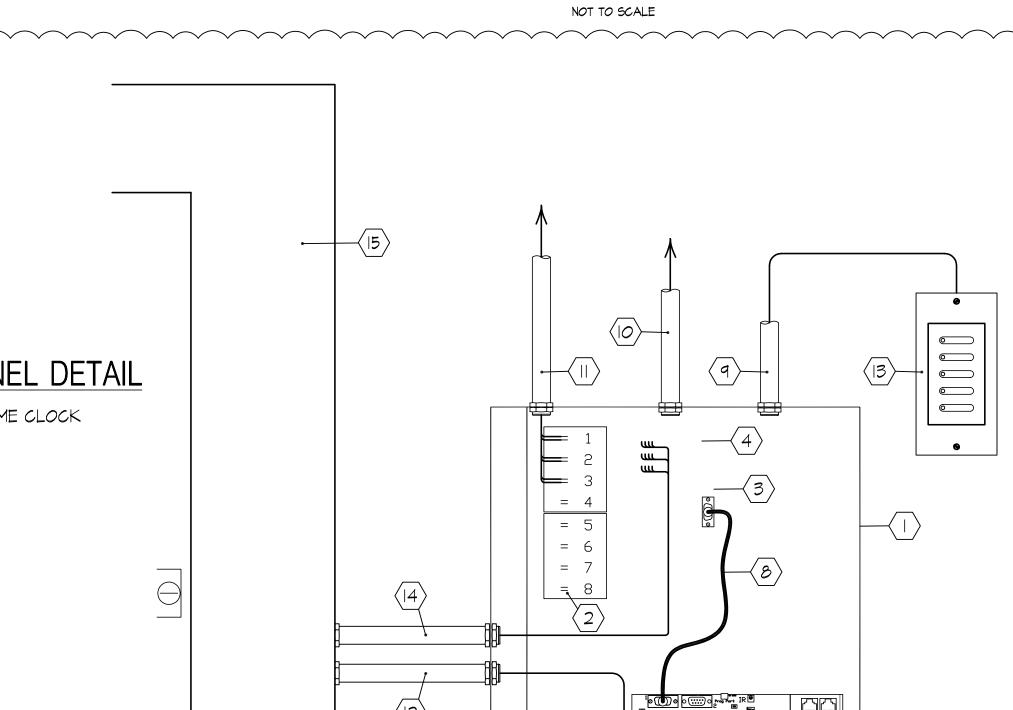

## General Notes:

LIGHTING CONTROLS SHALL MEET FLORIDA BUILDING CODE 2014
REQUIREMENTS. CONTRACTOR SHALL PROVIDE PROGRAMMING AS
DIRECTED BY OWNER. CONTRACTOR SHALL SET UP A PRE-CONSTRUCTION
COMMISSIONING MEETING TO ENSURE ALL DEVICES INSTALLED WILL MEET
THE NEEDS OF THE OWNER, FINALIZE DIGITAL SWITCH PROGRAMMING
BUTTONS, AND FINALIZE TIME CLOCK SCHEDULING.

\* EXISTING LIGHT FIXTURE FURNISHED BY OWNER, CONTRACTOR INSTALLED.

## LIGHTING CONTROL PROGRAM SCHEDULE

RELAY	AY CIRCUIT DESCRIPTION		GROUP SWITCH CARD		REMARKS	
No.	CIICOII	DESCINI HON	CHANNEL	FUNCTION	INLIMINING	
1	LA-5	FLAG POLE LIGHTING	"a"	ON - OFF	PUSH BUTTON CONTROL AND TIME CLOCK FOR SPECIAL EVENTS.	
2	LA-6	CANOPY LIGHTING	"b"	ON - OFF	PUSH BUTTON CONTROL AND TIME CLOCK FOR SPECIAL EVENTS.	
3	LA-2	EXTERIOR WALL PACK LIGHTING	"c"	ON - OFF	PHOTOCELL ON AT DUSK, TIME PROGRAM OFF; DAY LIGHT SENSOR OVERRIDE	
4	_	-	-	ON - OFF		
5	_	_	-	ON - OFF		
6	_	_	-	ON - OFF		
7	_	-	-	ON - OFF		
8	PA-9	OFFICE RECEPTACLES	-	ON - OFF		

## Key Notes: LIGHTING CONTROL PANEL DETAIL

- LIGHTING CONTROL PANEL & RELAY PANEL WITH TIME CLOCK AND PHOTO CELL CONTROL. WATTSTOPPER No. LMCP8-115/277-8HDR-277-LENC8S.
- 2 HDR RELAY
- (3) RELAY DRIVER BOARD
- 4 RELAY OVERRIDE BUTTON
- 5 DLM NETWORK CONNECTIONS
- 6 BACNET MS/TP CONNECTION
- (7) GROUB 1-8 BUTTONS
- 8 DB9 CABLE
- 9 LOW VOLTAGE CONTROL WIRES TO KEYPAD
- LOW VOLTAGE CONTROL WIRES TO PHOTOCELL LOCATED ON ROOF
- (II) CONDUIT AND CONDUCTORS TO LIGHTING FIXTURES
- (12) 2 #12, I #12 GND IN 3/4" CONDUIT FROM 20A/IP BREAKER IN PANEL FOR 277 VOLT CONTROL POWER
- (13) DIGITAL KEYPAD
- (14) LIGHTING BRANCH CIRCUIT CONDUCTORS IN CONDUIT
- (15) PANEL "LA" 480/277 VOLT, 3 PHASE, 4 WIRE

LIGHTING CONTROL PANEL DETAIL "C" - TYPICAL

NOT TO SCALE

**Dewberry** PREBLE-RISH

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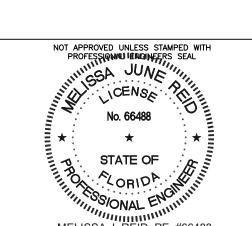
GULF COAST STATE COLLEGE

> 5230 US-98 PANAMA CITY, FLORIDA 32401 850.169.1551 gulfcoast.edu

> > PROJECT:

GCSC SOFTBALL COMPLEX






RELEASE:

CONSTRUCTION DOCUMENTS

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DRA\ T. A. I	WN: BOLTON	CHECKED: M. J. REID	
NO.	REVISION:		DATE:
1	ADDENDUM No. 1		6-1-1
	SHEET	TITLE:	

LIGHTING FIXTURE SCHEDULE

PROJECT NO. SHEET **E3** 

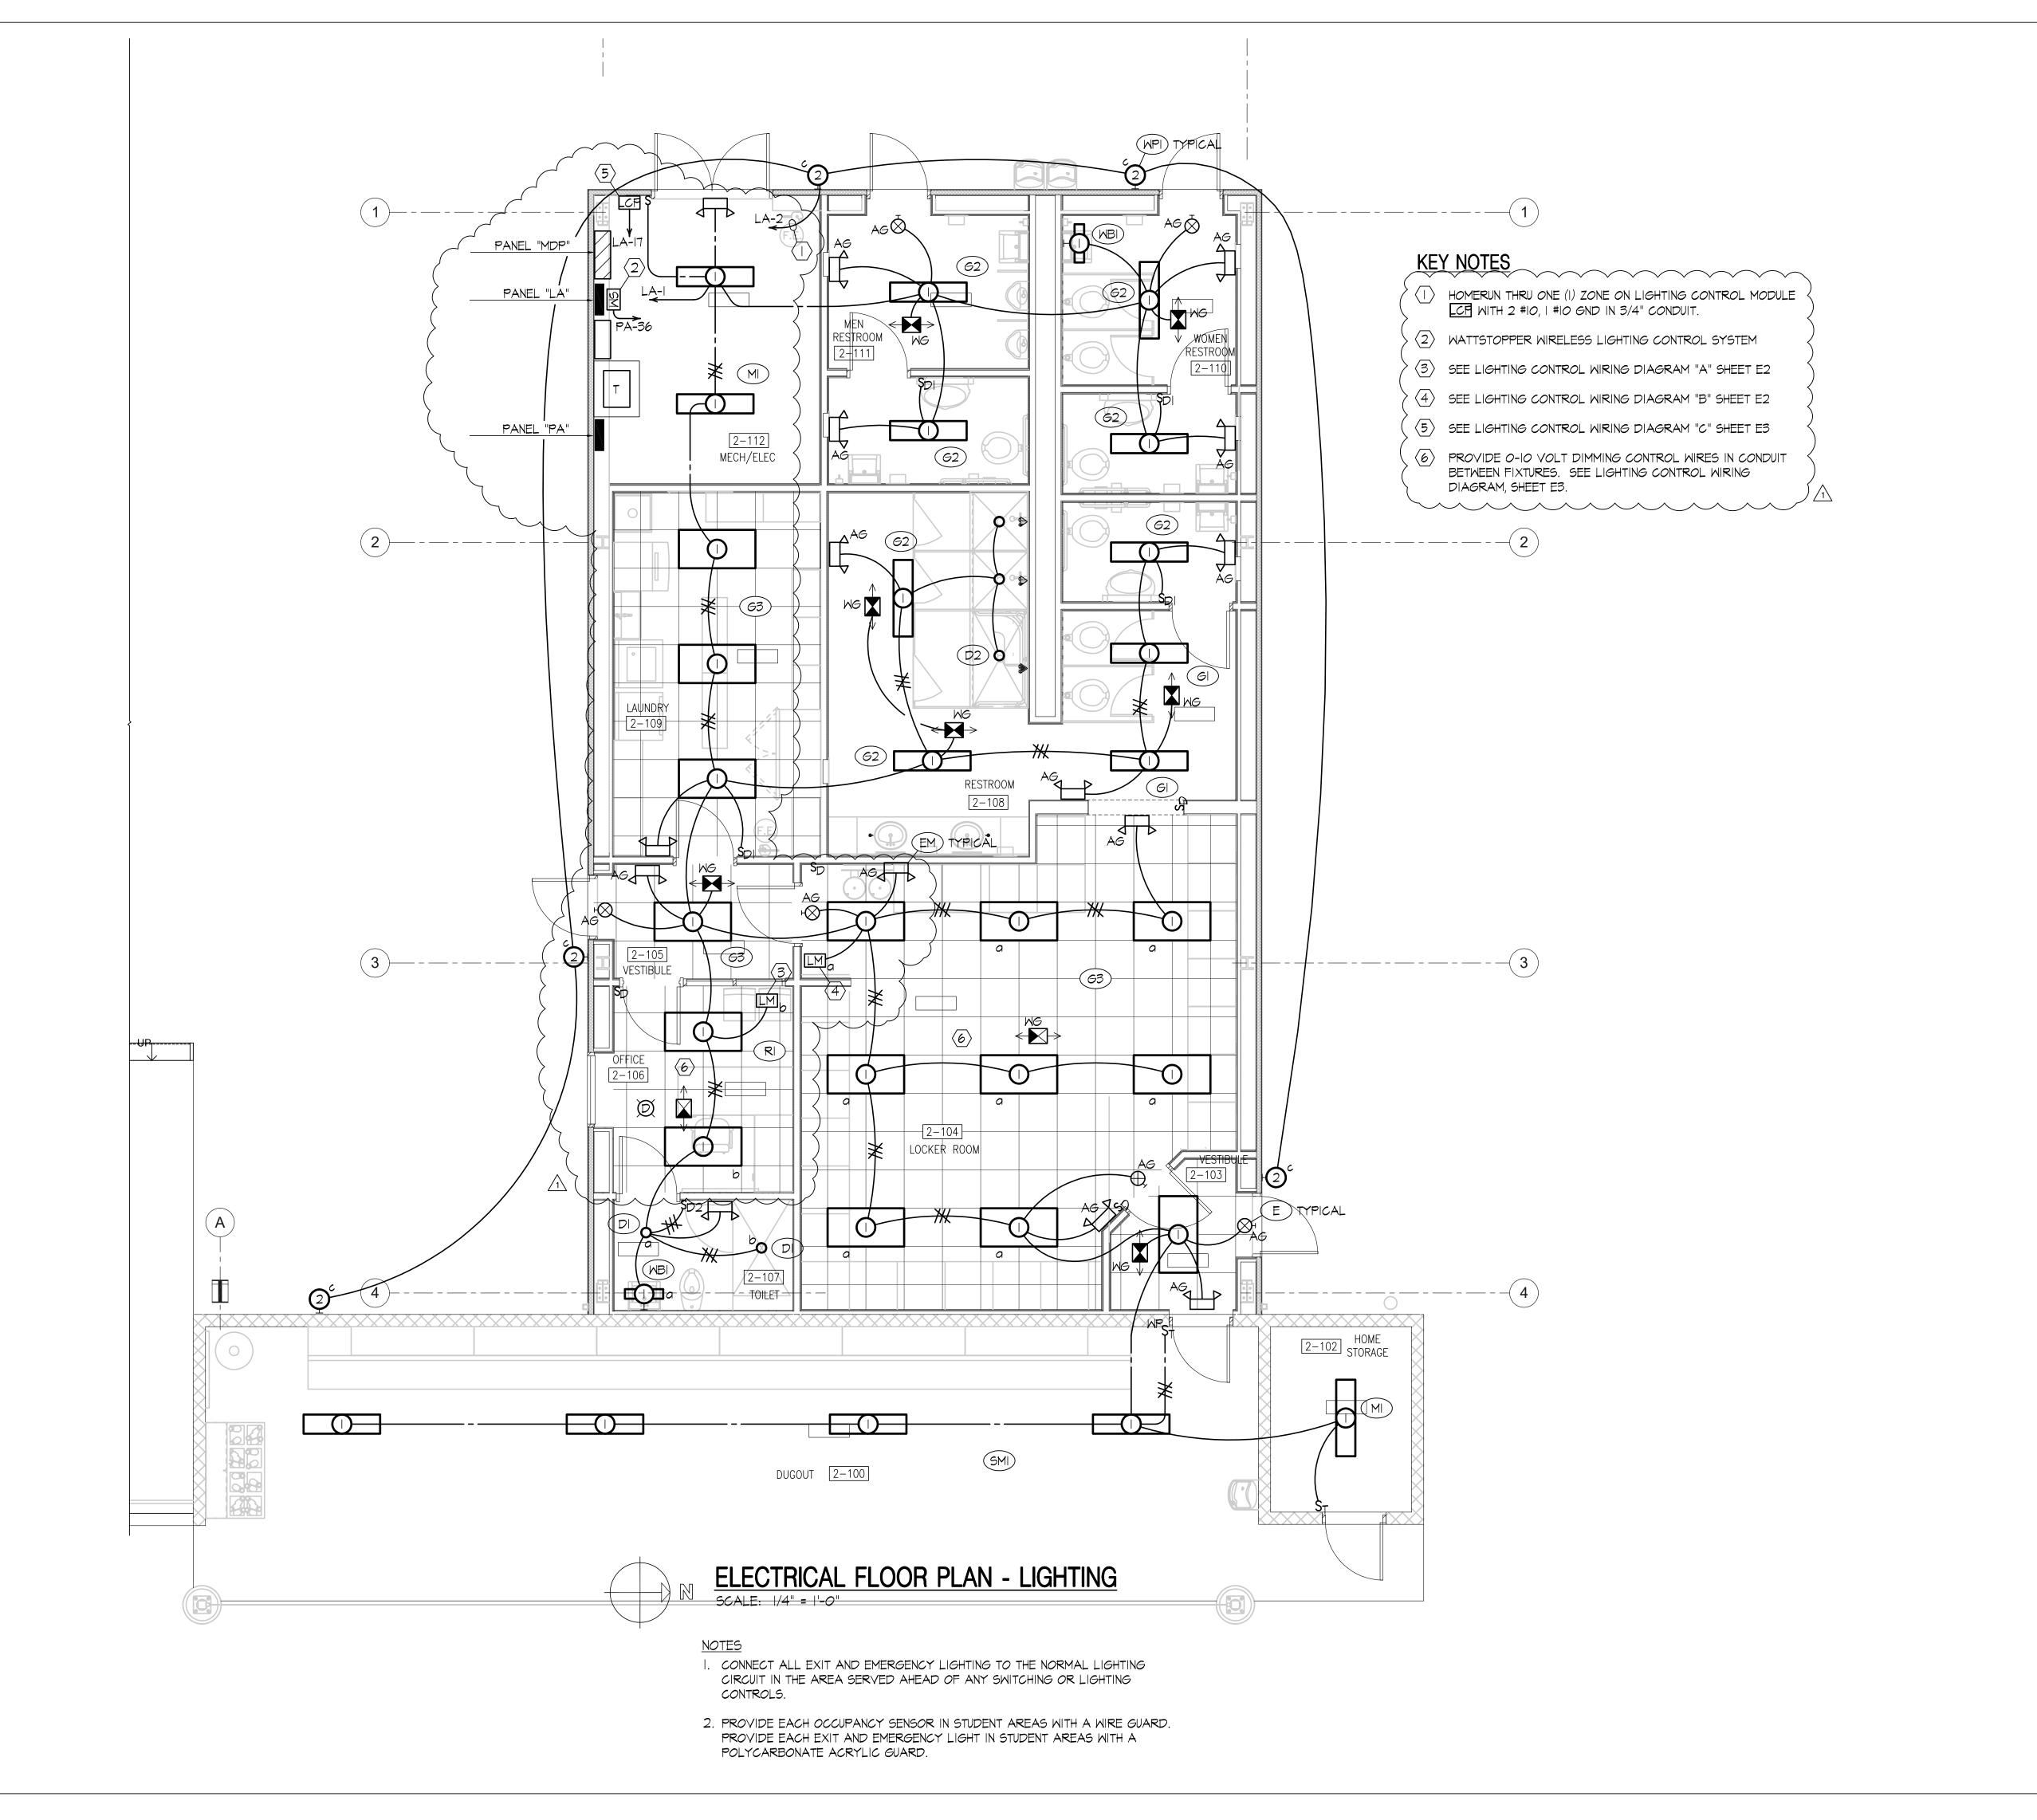

203 ABERDEEN PKWY, PANAMA CITY, FL 32405 (850) 522-0644

F L O R I D A
ARCHITECTS
LICENSE #AA0002730



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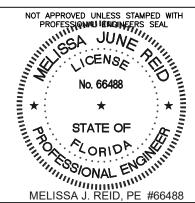
GULF COAST STATE COLLEGE

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PROJECT:

GCSC SOFTBALL COMPLEX





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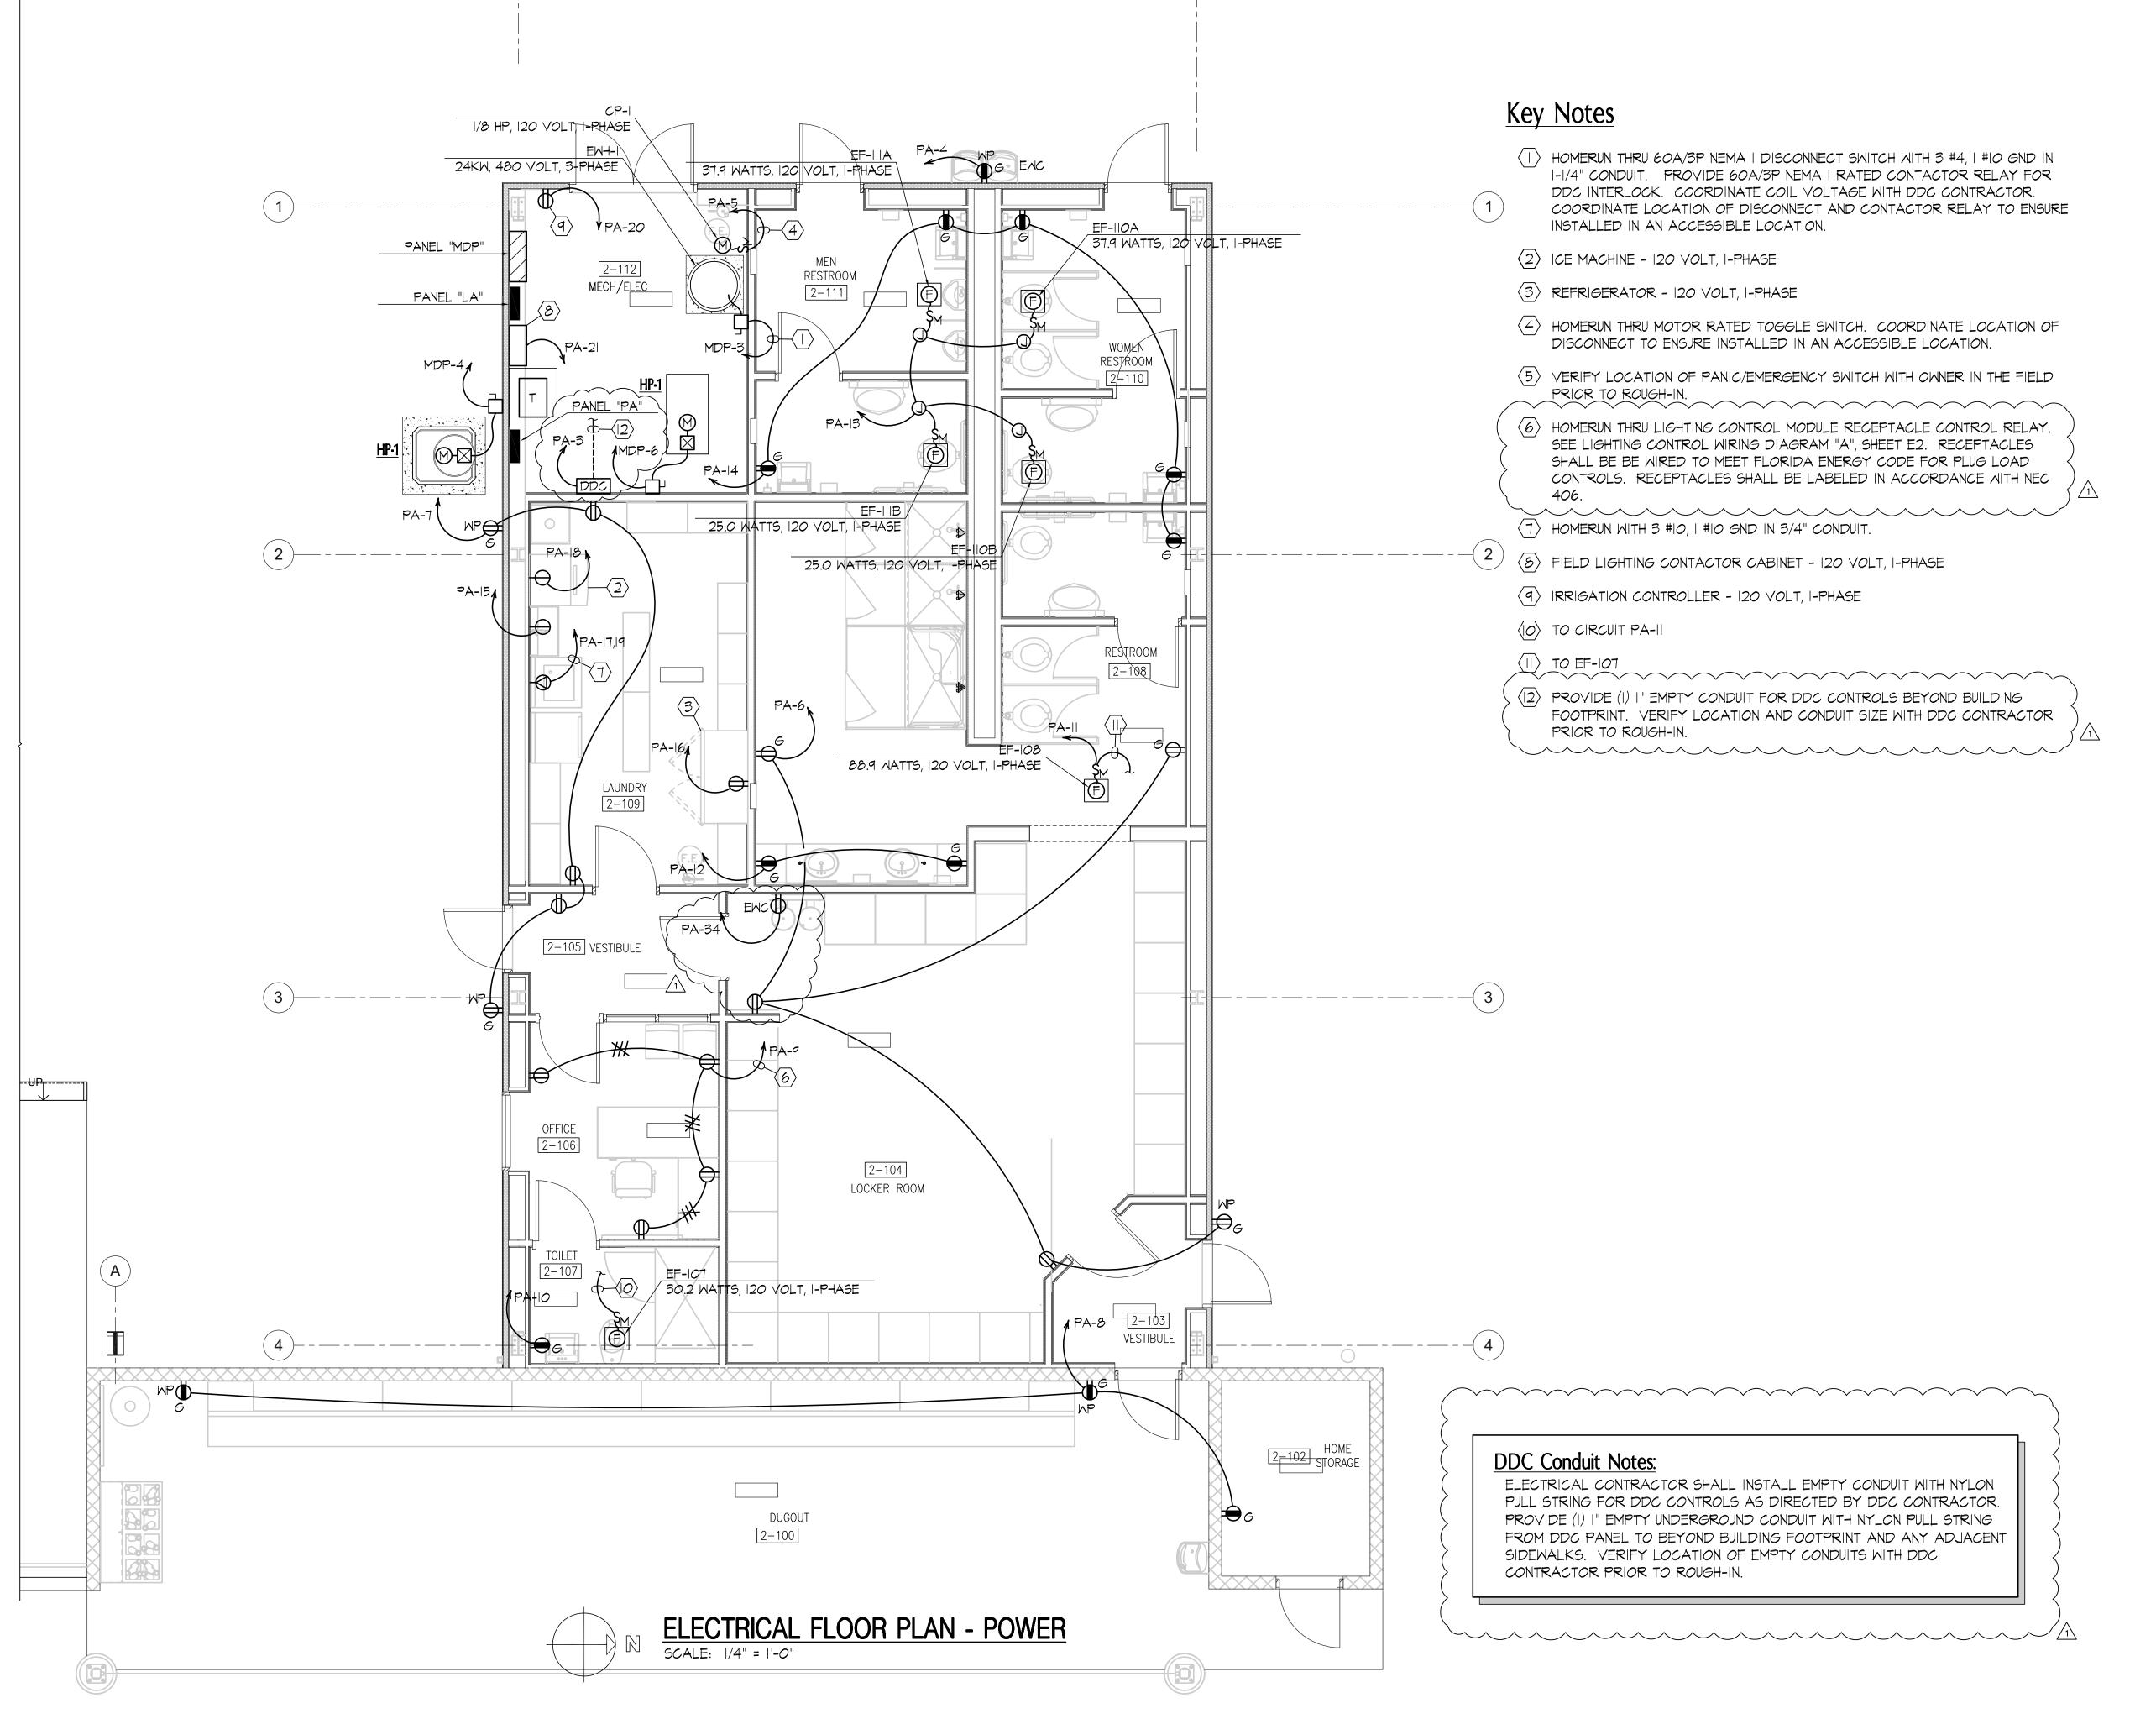
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	WN: BOLTON	CHECKED: M. J. REID	
NO.	REVISION:	·	DATE:
1	ADDENDUM No. 1		6-1-17

SHEET TITLE:

ELECTRICAL HOME LOCKER FACILITY

PROJECT NO. SHEET **E5** 



203 ABERDEEN PKWY, PANAMA CITY, FL 32405 (850) 522-0644





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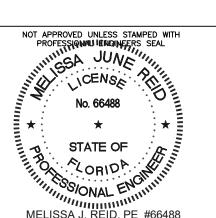
GULF COAST STATE COLLEGE

5230 US-98 PANAMA CITY, FLORIDA 32401 850.169.1551 gulfcoast.edu

PROJECT:

GCSC SOFTBALL COMPLEX





RELEASE:


CONSTRUCTION DOCUMENTS

SCALE: As indicated		DATE: 05/04/2017	
DRAWN: T. A. BOLTON		CHECKED: M. J. REID	
NO.	REVISION:		DATE:
1	ADDENDUM No. 1		6-1-17
			<b>'</b>

SHEET TITLE:

ELECTRICAL HOME LOCKER FACILITY

PROJECT NO. SHEET E6

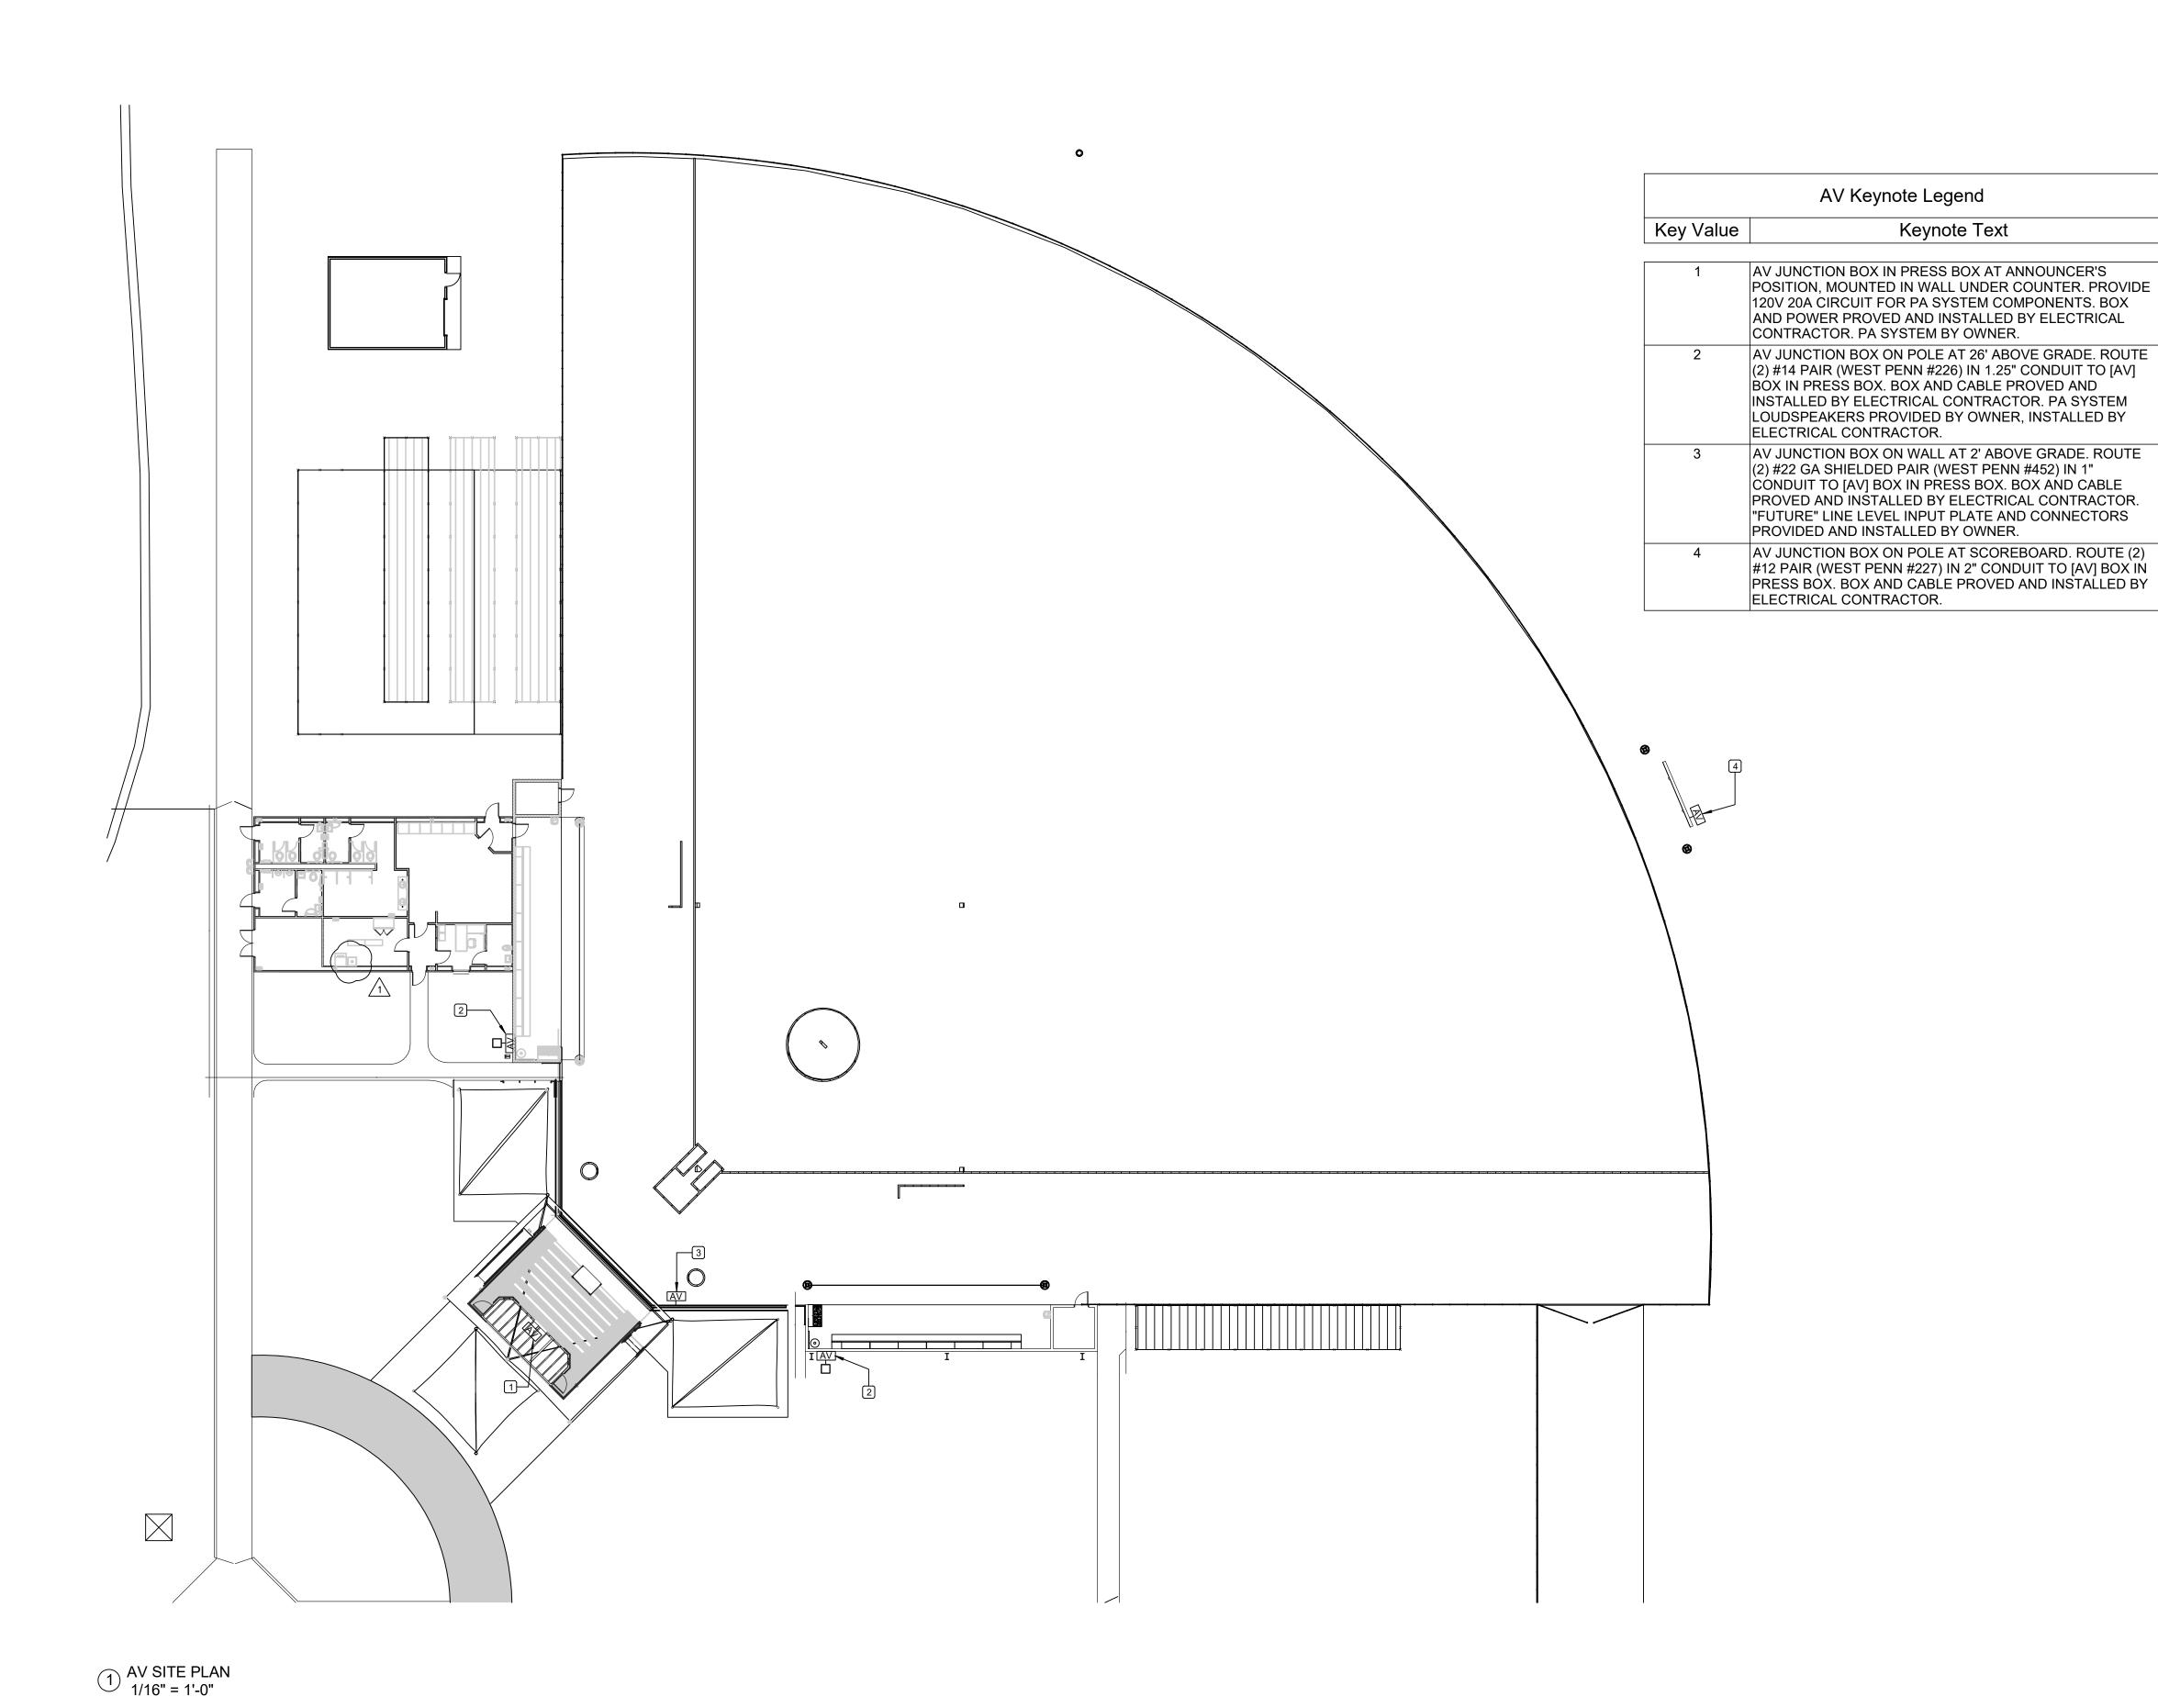

Keynote Text

203 ABERDEEN PKWY, PANAMA CITY, FL 32405 (850) 522-0644






CLIENT:

**GULF COAST STATE** COLLEGE

> 5230 US-98 PANAMA CITY, FLORIDA 32401 850.169.1551 gulfcoast.edu

> > PROJECT:

GCSC SOFTBALL COMPLEX

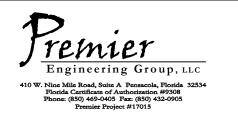



RELEASE:

CONSTRUCTION DOCUMENTS

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NO.	REVISION:		DATE:
1	ADDENDUM No. 1		6-1-17
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A/V SITE PLAN



PROJECT NO. 4226